

#### SITE CLEARING & DEMOLITION NOTES:

1. EXISTING FEATURES SHOWN ARE FROM FIELD SURVEY. UNDERGROUND UTILITIES SHOULD BE CONSIDERED APPROXIMATE.

2. DEMOLITION INCLUDES THE FOLLOWING WITHIN THE LIMITS OF DISTURBANCE:

A) TRANSFER BENCHMARK CONTROL TO NEW LOCATIONS OUTSIDE THE DISTURBED AREA PRIOR TO COMMENCING DEMOLITION A) TRANSFER BENCHMARK CONTROL TO NEW LOCATIONS OUTSIDE THE DISTURBED AREA PRIOR TO COMMISSING DEMOCITION OPERATIONS (WHEN APPLICABLE)
B) PROVIDE TEMPORARY BARRICADES AND OTHER FORMS OF PROTECTION AS REQUIRED TO PROTECT OWNER'S PERSONNEL PROPERTY AND GENERAL PUBLIC FROM INJURY DUE TO DEMOLITION WORK.
C) DEMOLITION AND REMOVAL OF EXISTING SITE FEATURES.
D) DISCONNECTING, CAPPING OR SEALING, AND ABANDONING/REMOVING SITE UTILITIES IN PLACE (WHICHEVER IS APPLICABLE)

3. PROMPTLY REMOVE WASTE MATERIALS AND OTHER CLEARING DEBRIS FROM PROPERTY AND DISPOSE OF OFF SITE AT A TDEC

4. REMOVE AND LEGALLY DISPOSE OF ITEMS EXCEPT THOSE INDICATED TO BE REINSTALLED, SALVAGED, OR TO REMAIN. 5. EXISTING FOUNDATIONS AND UTILITIES MAY BE ENCOUNTERED ACROSS THE SITE. IF ENCOUNTERED, THESE ITEMS MAY REQUIRE REMOVAL AS INDICATED ON THE DRAWINGS. RESULTING EXCAVATIONS SHOULD BE BACKFILLED WITH PROPERLY COMPACTED SELECT

6. REMOVAL INCLUDES DIGGING OUT STUMPS AND ROOTS. REMOVE ALL STUMPS, ROOTS OVER 4-INCHES IN DIAMETER AND MATTED ROOTS WITHIN THE LIMITS OF GRUBBING TO DEPTHS AS FOLLOWS: A) FOOTINGS: 18 INCHES

B) WALKS: 12 INCHES C) ROADS: 18 INCHES

D) PARKING AREAS: 12 INCHES E) LAWN AREAS: 18 INCHES F) FILLS: 12 INCHES

7. REMOVE, REINSTALL, AND RELOCATE: ITEMS INDICATED; CLEAN, SERVICE, AND OTHERWISE PREPARE THEM FOR REUSE; STORE AND PROTECT AGAINST DAMAGE, REINSTALL ITEMS IN LOCATIONS INDICATED. 8. PROVIDE PROTECTION NECESSARY TO PREVENT DAMAGE TO EXISTING IMPROVEMENTS INDICATED TO REMAIN IN PLACE. PROTECT BENCHMARKS, EXISTING STRUCTURES, ROADS, SIDEWALKS, PAVING AND CURBS AGAINST DAMAGE FROM VEHICULAR OR FOOT TRAFFIC.

A) PROTECT IMPROVEMENTS ON ADJOINING PROPERTIES AND ON THE OWNER'S PROPERTY.

B) RESTORE DAMAGED IMPROVEMENTS TO THEIR ORIGINAL CONDITION, AS ACCEPTABLE TO PARTIES HAVING JURISDICTION.

9. COMPLY WITH APPLICABLE REQUIREMENTS OF FEDERAL, STATE AND LOCAL LAWS, REGULATIONS AND CODES OF THE AUTHORITIES HAVING JURISDICTION FOR THE DISPOSAL OF ALL DEBRIS MATERIAL. 10. CONDUCT SITE CLEARING OPERATIONS TO ENSURE MINIMUM INTERFERENCE WITH ROADS, STREETS, WALKS AND OTHER ADJACENT OCCUPIED OR USED FACILITIES. DO NOT CLOSE OR OBSTRUCT STREETS, WALKS OR OTHER OCCUPIED OR USED FACILITIES WITHOUT PERMISSION FROM AUTHORITIES HAVING JURISDICTION.

11. OBTAIN APPROVED BORROW SOIL MATERIALS OFF-SITE WHEN SUFFICIENT SATISFACTORY SOIL MATERIALS ARE NOT AVAILABLE

12. MAINTAIN EXISTING UTILITIES INDICATED TO REMAIN IN SERVICE AND PROTECT THEM AGAINST DAMAGE THROUGHOUT CONSTRUCTION OPERATIONS.

A) DO NOT INTERRUPT EXIST UTILITIES SERVING OCCUPIED OR OPERATING FACILITIES, EXCEPT WHEN AUTHORIZED IN WRITING BY ENGINEER AND AUTHORITIES HAVING JURISDICTION. PROVIDE TEMPORARY SERVICES DURING INTERRUPTIONS TO EXISTING UTILITIES, AS ACCEPTABLE TO OWNER AND TO GOVERNING AUTHORITIES.

B) CONTRACTOR SHALL COORDINATE WITH APPROPRIATE UTILITY OWNER WHEN DISCONNECTING, REMOVING, OR RELOCATING EXISTING UTILITY SERVICES EXISTING UTILITY SERVICES."

13. CONDUCT DEMOLITION OPERATIONS TO PREVENT INJURY TO PEOPLE AND DAMAGE TO ADJACENT BUILDINGS AND FACILITIES TO REMAIN. ENSURE SAFE PASSAGE OF PEOPLE AROUND DEMOLITION AREA.

A) ERECT TEMPORARY PROTECTION, BARRICADES AS PER LOCAL GOVERNING AUTHORITIES.
B) PROTECT EXISTING SITE IMPROVEMENTS AND APPURTENANCES TO REMAIN.

14. EXPLOSIVES: NO EXPLOSIVES SHALL BE STORED ON SITE.

15. REMOVE AND TRANSPORT DEBRIS IN A MANNER THAT WILL PREVENT SPILLAGE ON ADJACENT SURFACES AND AREAS. 16. CLEAN ADJACENT BUILDINGS AND IMPROVEMENT OF DUST, DIRT, AND DEBRIS CAUSED BY DEMOLITION OPERATIONS. RETURN ADJACENT AREAS TO CONDITION EXISTING BEFORE START OF DEMOLITION.

17. DAMAGES: PROMPTLY REPAIR DAMAGES TO ADJACENT FACILITIES CAUSED BY DEMOLITION OPERATIONS AT THE CONTRACTORS

18. REMOVE EXISTING ABOVE-GRADE AND BELOW-GRADE IMPROVEMENTS NECESSARY TO PERMIT CONSTRUCTION AND OTHER WORK 19. GENERAL: PROMPTLY DISPOSE OF DEMOLISHED MATERIALS. DO NOT ALLOW DEMOLISHED MATERIALS TO ACCUMULATE ON-SITE. 20. DO NOT BURN OR BURY MATERIALS ON SITE.

21. CONTRACTOR TO SAWCUT EXISTING PAVEMENT TO REMAIN PRIOR TO CURB, GUTTER, PAVEMENT, ETC. REMOVAL.

22. IN TENNESSEE IT IS A REQUIREMENT PER "THE UNDERGROUND UTILITY DAMAGE PREVENTION ACT" THAT ANYONE WHO ENGAGES IN EXCAVATION MUST NOTIFY ALL KNOWN UTILITY OWNERS, NO LESS THAN THREE NOR MORE THAN TEN WORKING DAYS, PRIOR TO THEIR INTENDED EXCAVATION. A LIST OF THESE UTILITY OWNERS MAY BE OBTAINED FROM THE COUNTY REGISTER OF DEEDS. THOSE UTILITY OWNERS WHO PARTICIPATE IN THE TENNESSEE ONE CALL SYSTEM CAN BE NOTIFIED TOLL FREE AT 1-800-351-1111. 23. UTILITIES SHOWN ARE BASED ON VISUAL OBSERVATIONS AND UTILITY MARKINGS. CONTRACTOR SHALL CALL TN ONE CALL AND CONFIRM LOCATIONS PRIOR TO STARTING WORK.

24. CONTRACTOR SHALL PREVENT TRACKING ONTO ADJACENT ROADWAYS. SHOULD TRACKING OF EARTH HAPPEN, THE CONTRACTOR SHALL CLEAN THE AREA IMMEDIATELY.

1. PRIOR TO STARTING CONSTRUCTION THE CONTRACTOR SHALL BE RESPONSIBLE FOR MAKING SURE THAT ALL REQUIRED PERMITS AND APPROVALS HAVE BEEN OBTAINED. NO CONSTRUCTION OR FABRICATION SHALL BEGIN UNTIL THE CONTRACTOR HAS RECEIVED AND THOROUGHLY REVIEWED ALL PLANS AND OTHER DOCUMENTS APPROVED BY ALL OF THE PERMITTING AUTHORITIES. 2. ALL WORK SHALL BE PERFORMED IN ACCORDANCE WITH THESE PLANS, SPECIFICATIONS, AND THE REQUIREMENTS AND STANDARDS OF THE LOCAL GOVERNING AUTHORITY. IF PROVIDED, THE SOILS REPORT AND RECOMMENDATIONS SET FORTH THEREIN ARE A PART OF THE REQUIRED CONSTRUCTION DOCUMENTS AND TAKE PRECEDENCE UNLESS SPECIFICALLY NOTED OTHERWISE ON THE PLANS. THE CONTRACTOR SHALL NOTIFY THE CONSTRUCTION/PROJECT MANAGER OF ANY DISCREPANCY BETWEEN SOILS REPORT AND PLANS,

3. UPON RECEIPT OF POINT COORDINATE DATA, THE CONTRACTOR SHALL RUN AN INDEPENDENT VERTICAL CONTROL TRAVERSE TO CHECK BENCHMARKS AND A HORIZONTAL CONTROL TRAVERSE THROUGH GIVEN POINTS TO CONFIRM GEOMETRIC DATA AND SUBMIT TO THE ENGINEER PRIOR TO ANY CONSTRUCTION.

4. THE LOCATIONS OF UNDERGROUND FACILITIES SHOWN ON THE PLAN ARE BASED ON FIELD SURVEYS AND CITY RECORDS. IT SHALL BE THE CONTRACTOR'S FULL RESPONSIBILITY TO CONTACT THE VARIOUS UTILITY COMPANIES TO LOCATE THEIR FACILITIES PRIOR TO THE STARTING CONSTRUCTION. NO ADDITIONAL COMPENSATION SHALL BE PAID TO THE CONTRACTOR FOR WORK HAVING TO BE REDONE DUE TO INFORMATION SHOWN INCORRECTLY ON THESE PLANS IF SUCH NOTIFICATION HAS NOT BEEN GIVEN. 5. ALL WORK WITHIN THE RIGHTS OF WAY SHALL BE IN ACCORDANCE WITH THE GOVERNING JURISDICTION AND SPECIFICATIONS 6. CONTRACTOR SHALL COORDINATE ANY MAINTENANCE OF TRAFFIC WITH THE OWNER'S REPRESENTATIVE AND THE LOCAL JURISDICTION PRIOR TO CONSTRUCTION.

7. CONTRACTOR SHALL AT ALL TIMES ENSURE THAT MEASURES FOR PROTECTING EXISTING DRAINAGE FACILITIES BE IN PLACE PRIOR TO THE COMMENCEMENT OF ANY PHASE OF THE SITE CONSTRUCTION OR LAND ALTERATION. 8. UPON COMPLETION OF PROJECT, CONTRACTOR SHALL CLEAN THE PAVED AREAS PRIOR TO REMOVAL OF TEMPORARY SEDIMENT CONTROLS, AS DIRECTED BY THE CITY AND/OR CONSTRUCTION/PROJECT MANAGER. IF POWER WASHING IS USED, NO SEDIMENT LADEN WATER SHALL BE WASHED INTO THE STORM SYSTEM. ALL SEDIMENT LADEN MATERIAL ON PAVEMENT OR WITHIN THE STORM SYSTEM SHALL BE COLLECTED AND REMOVED FROM THE SITE AT CONTRACTOR'S EXPENSE.

9. ROCK EXCAVATION WILL BE CONSIDERED UNCLASSIFIED. NO EXTRA COMPENSATION SHALL BE GIVEN FOR ROCK EXCAVATION. 10. THESE PROJECT CONSTRUCTION DOCUMENTS SHALL NOT CONSTITUTE A CONTRACTUAL RELATIONSHIP BETWEEN THE ENGINEER AND THE CONTRACTOR. 11. THE ENGINEER SHALL NOT BE RESPONSIBLE FOR CONSTRUCTION OF SAFETY MEANS, METHODS, TECHNIQUES, SEQUENCE'S, OR PROCEDURES UTILIZED BY THE CONTRACTOR OR SUBCONTRACTORS.

12. CONTRACTOR TO COORDINATE WITH THE CITY OF CROSSVILLE ENGINEERING DEPARTMENT PRIOR TO COMMENCEMENT OF ANY WORK IN THE PUBLIC RIGHT-OF-WAY.

#### SITE NOTES:

1. THE LOCATION OF THE EXISTING UTILITES IS APPROXIMATE. THE CONTRACTOR SHALL NOTIFY ALL UTILITY OWNERS PRIOR TO BEGINNING CONSTRUCTION OPERATIONS TO DETERMINE THE EXACT LOCATION OF EXISTING UTILITIES. THE CONTRACTOR SHALL IDENTIFY AND PROTECT FROM DAMAGE ALL UTILITIES WHICH ARE TO REMAIN. 2. LANDSCAPE AROUND BUILDING BY ALLOWANCE

3. ALL DISTURBED AREAS OUTSIDE OF BUILDING AND PAVEMENT SHALL RECEIVE A MINIMUM OF 6" OF TOPSOIL AND 6 INCHES OF

4. ALL DIMENSIONS ARE TO FACE OF BUILDING, FACE OF CURB, ETC.


5. REFER TO THE ARCHITECTURAL DRAWINGS FOR EXACT BUILDING DIMENSIONS. DO NOT USE ENGINEERING PLANS FOR BUILDING 6. PAVEMENT MARKING SHALL BE MARKED WITH ASPHALT PAVEMENT MARKING PAINIT ONLY. STRIPING SHALL BE 4" IN WIDTH. COLOR SHALL BE WHITE UNLESS OTHERWISE SHOWN.




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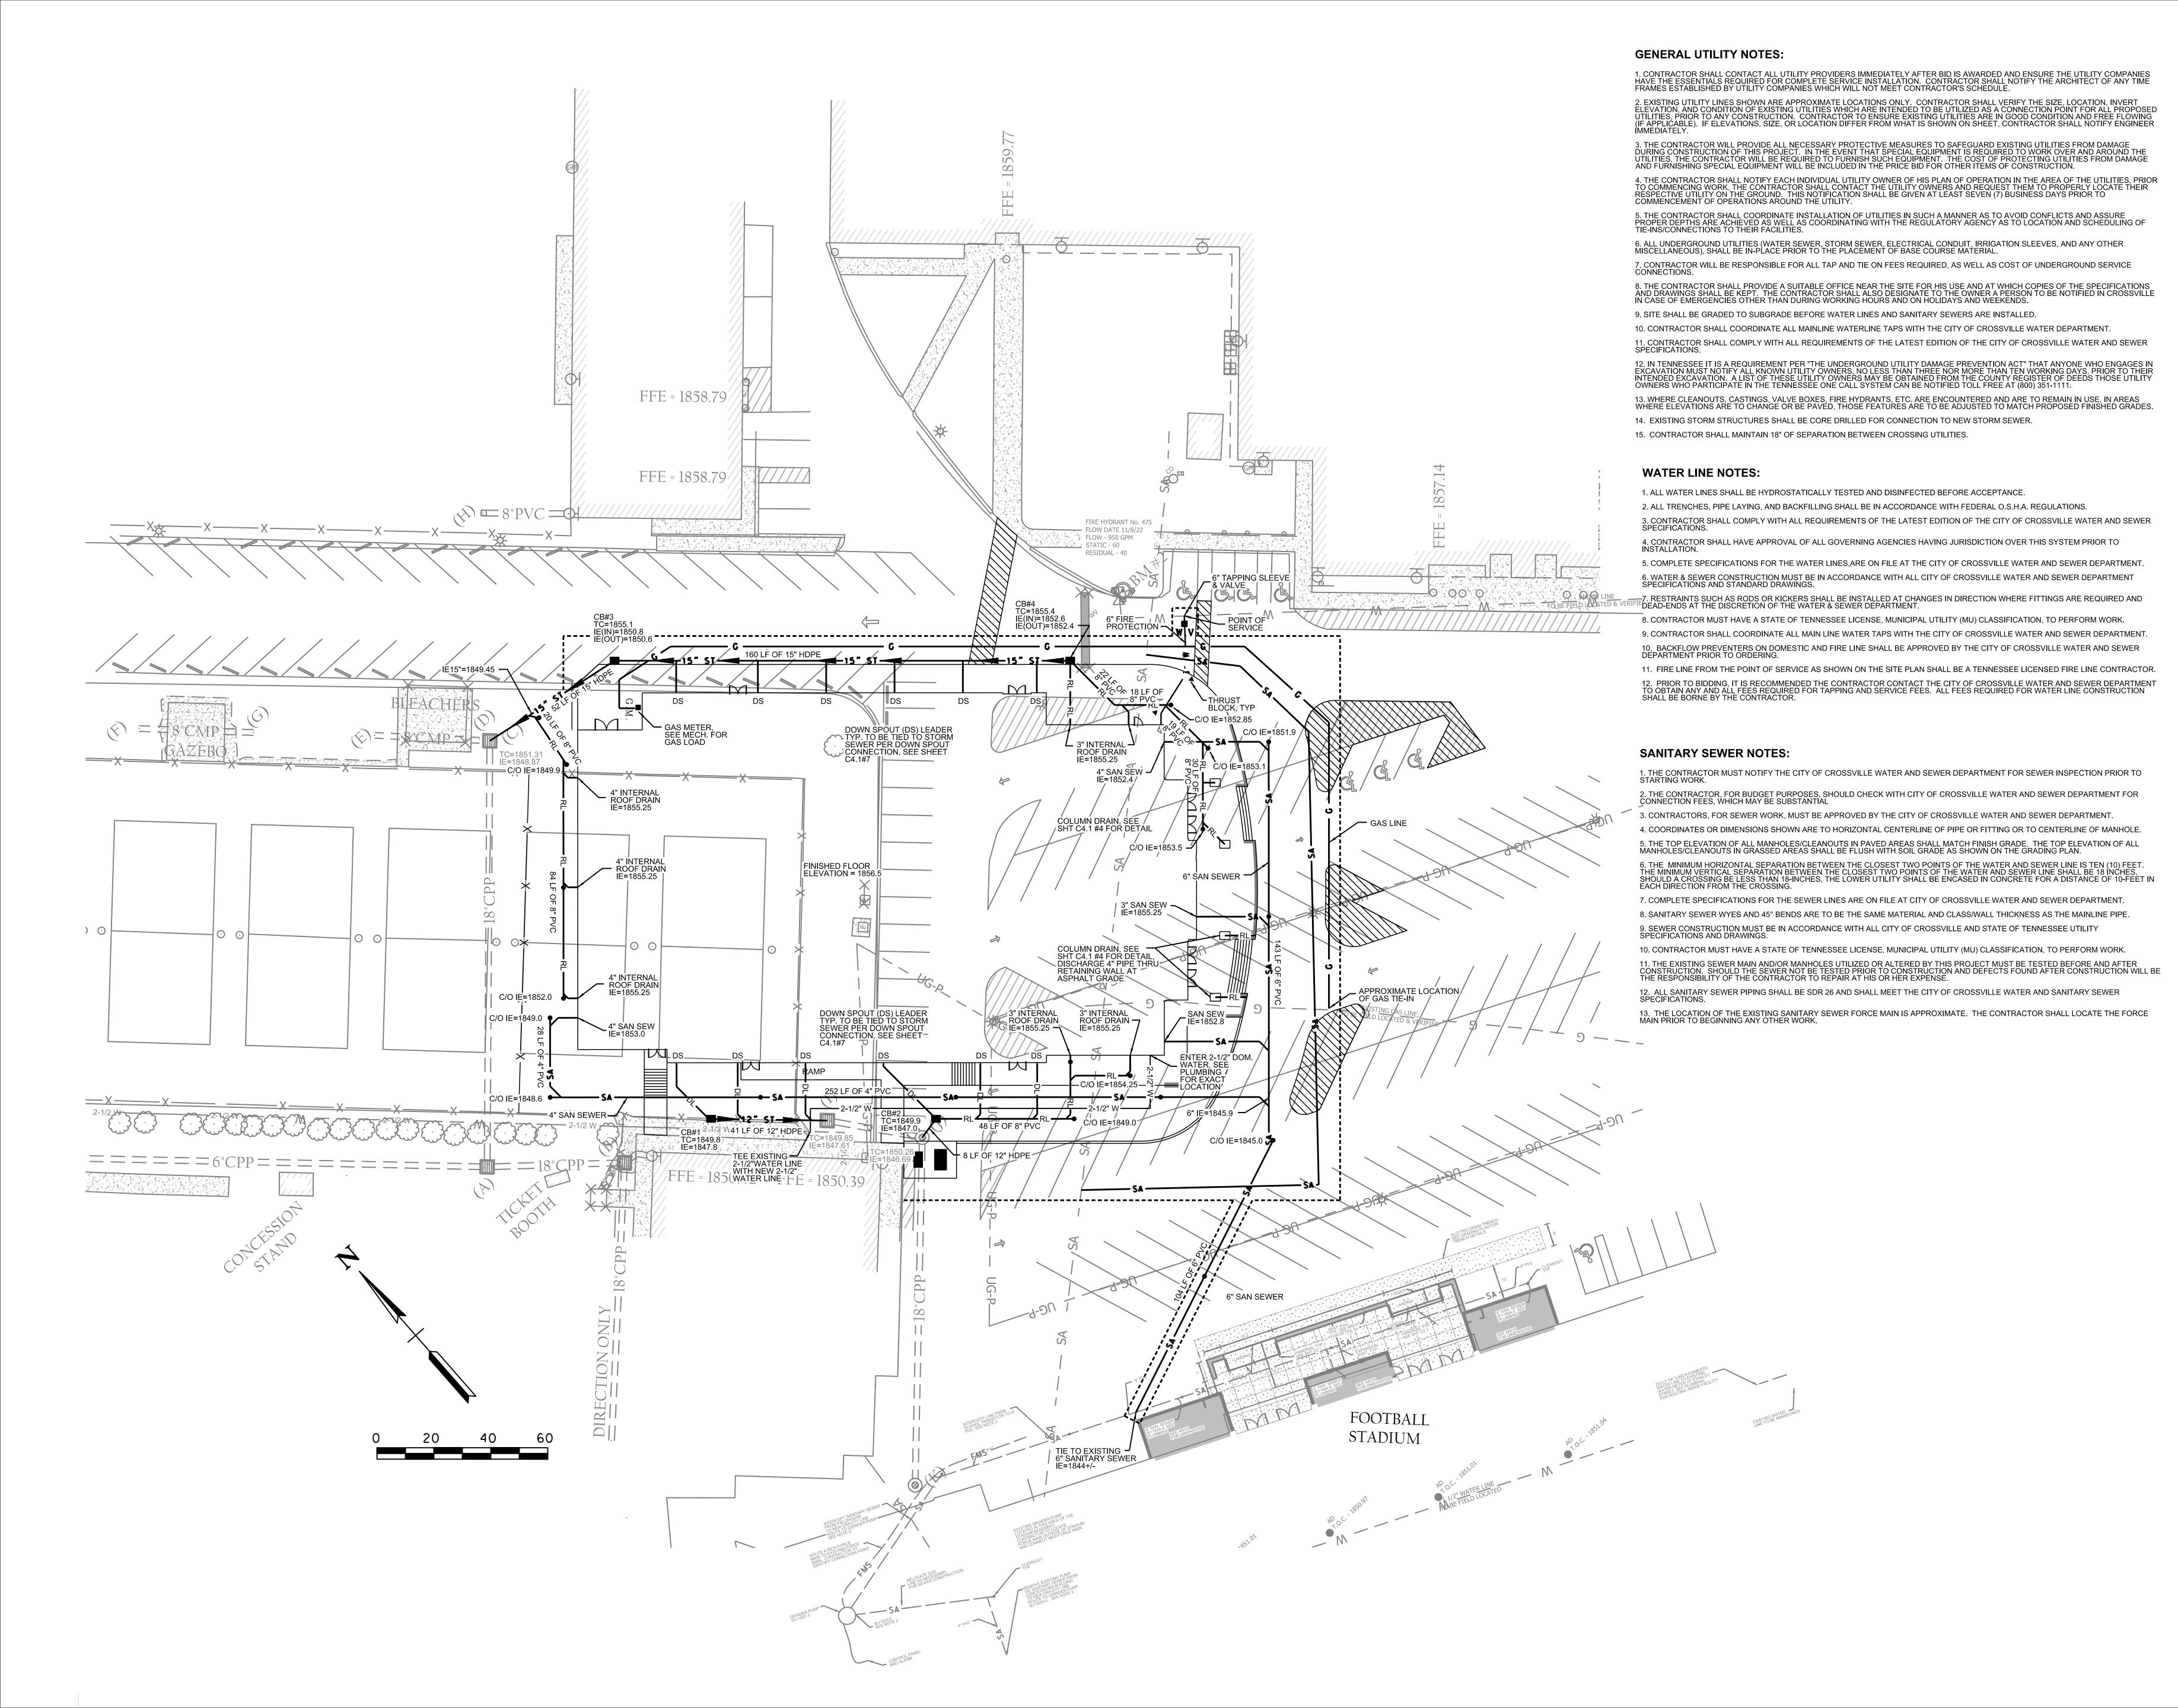


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JOB NO.	2220
	2229
ISSUE DATE	
	1-30-2023
SHEET TITLE	
	SITE PLAN
	JIIL FLAN
DRAWN	
DSN	C11
REVIEW	C1.1
DSN	



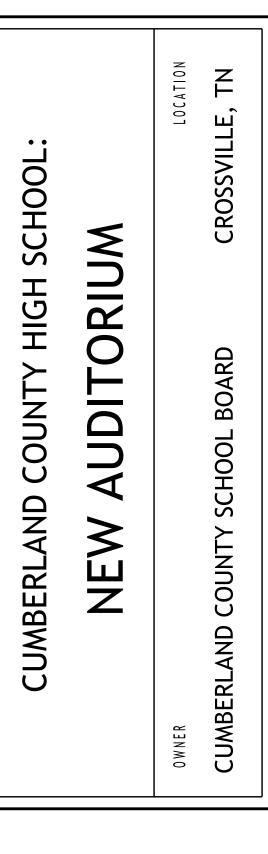
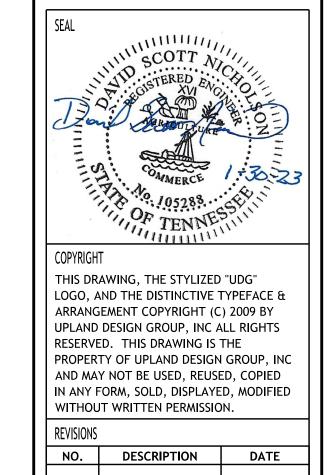
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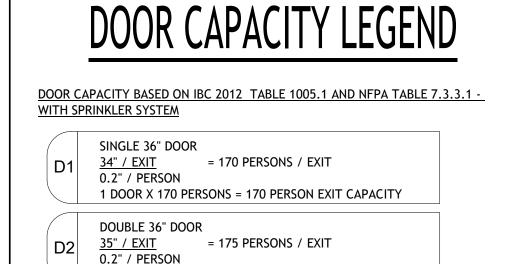
1-30-2023

SHEET TITLE

UTILITY PLAN

DRAWN
DSN
REVIEW

C3.1



2 DOORS X 175 PERSONS = 350 PERSON EXIT CAPACITY = 230 PERSONS / EXIT <u>46" / EXIT</u> 1 DOOR X 230 PERSONS = 230 PERSON EXIT CAPACITY

= 235 PERSONS / EXIT 47" / EXIT 0.2" / PERSON 2 DOORS X 235 PERSONS = 470 PERSON EXIT CAPACITY

### LIFE SAFETY SYMBOLS

INDICATES OCCUPANT LOAD AT EXIT

FIRE ALARM MANUAL PULL STATION - MOUNT 48" A.F.F.

FIRE EXTINGUISHER CABINET

BRACKET MOUNTED FIRE EXTINGUISHER

FIRE ALARM STROBE LIGHT - MOUNT 80" A.F.F., BUT NO CLOSER THAN 6" TO CEILING

FIRE ALARM COMBINATION AUDIBLE/VISUAL UNIT - MOUNT 80" A.F.F., BUT NO CLOSER THAN 6" TO CEILING

> MAGNETIC HOLD OPEN DEVICE CONNECTED TO FIRE ALARM CONTROL PANEL

SD SMOKE DETECTOR

HEAT RISE DETECTOR

FIRE ALARM CONTROL PANEL - PROVIDED WITH BATTERY BACKUP

FIRE ALARM ANNUCIATOR PANEL - PROVIDED WITH BATTERY BACKUP PER NFPA REQUIREMENTS.

DOOR EXIT REQUIREMENT CALCULATIONS

EXIT SIGN - SINGLE OR DOUBLE FACE, WALL OR CLG. MOUNTED AS INDICATED BY SYMBOL. DIRECTIONAL ARROWS SHALL BE PROVIDED AS SHOWN. EXIT SIGN SHALL BE EQUIPPED WITH A BATTERY PACK FOR OPERATION DURING LOSS OF NORMAL BUILDING POWER

EXTERIOR EMERGENCY LIGHTING UNIT

### OCCUPANT LOAD

TOTAL OCCUPANT LOAD (ENTIRE BUILDING): 1,693 PERSONS

MAIN ENTRANCE BANK OF DOORS INTO LOBBY MUST HANDLE HALF THE OCCUPANCY PER IBC 2012 1028.2

TOTAL AUDITORIUM OCCUPANT LOAD - 1,193 PERSONS REQUIRED MAIN ENTRANCE BANK OF DOORS - AT LEAST 600 PERSONS. THE CAPACITY OF THE PAIR OF DOUBLE DOORS ON ONE SIDE OF THE ENTRANCE INTO THE LOBBY IS 700 PERSONS.

# FLOOR AREA PER OCCUPANT

IBC 2012 EDITION SECTION 506.1

THEATER (ASSEMBLY -A1) ALLOWABLE AREA PER STORY: Aa = {At + [ At x If ] + [ At x Is ]}

 $Aa = \{ 8,500 + [ 8,500 \times .75 ] + [ 8,500 \times 3 ] \}$ 

 $Aa = \{ 8,500 + 6,375 + 25,500 \}$ Aa = 40,375 SQUARE FEET ALLOWABLE PER STORY - THEATER

26,272 SQUARE FEET ACTUAL

**AUTOMATIC SPRINKLER SYSTEM INCREASE - IBC 2012 EDITION SECTION 506.3** 

300% INCREASE (Is = 3) FOR BUILDINGS WITH NO MORE THAN ONE STORY ABOVE GRADE PLAN.

FRONTAGE INCREASE - IBC 2012 EDITION 506.2 FRONTAGE INCREASE: If = [ F / P - 0.25 ] W /30

If = [691'-6" / 601'-6" - 0.25] 30 / 30 If = [0.75] 1.0

# FLOOR AREA PER OCCUPANT

IBC 2012 EDITION TABLE 1004.1 - MAXIMUM FLOOR AREA ALLOWANCES PER OCCUPANT

(A1 X ) ASSEMBLY USE - STANDING SPACE - 5 S.F. NET / PERSON

ASSEMBLY USE FIXED SEATS (THEATER SEATING) - NUMBER OF SEATS (B X) BUSINESS USE - 100 S.F. GROSS / PERSON

(C X) MECHANICAL / STORAGE USE - 300 S.F. GROSS / PERSON

(D | X) STAGES AND PLATFORMS - 15 S.F. GROSS / PERSON

# RATED WALL SYMBOL LEGEND

SMOKE PARTITION WALL PER IBC 2012-SECTION 710 AND NFPA 2012-SECTION 8.4. WALL SHALL EXTEND FROM FLOOR OR FOUNDATION TO UNDERSIDE OF ROOF DECK ABOVE AND LIMIT THE TRANSFER OF SMOKE.

1 HOUR RATED WALL; FLOOR TO UNDERSIDE OF DECK ABOVE AT CONC. BLOCK LOCATIONS (SEE FLOOR PLANS) USE UL DESIGN U905 (NONLOAD BEARING), UL DESIGN U905 (LOAD BEARING), TERMINATE AT METAL DECK WITH UL SYSTEMS HWD 0022 (WALL PERPENDICULAR TO DECK FLUTES) OR HWD 0030 (WALL PARALLEL TO DECK FLUTES)

ALL INTERIOR WALLS SHALL EXTEND TO DECK ABOVE UNLESS NOTED OTHERWISE

OF WALLS.

PROVIDE 3" HIGH, BRIGHT RED STENCILED LETTERS VISIBLE ABOVE CEILING AT ALL CHANGES IN DIRECTION AND AT 30' INTERVALS ALONG ALL RATED WALLS READING \_ HOUR FIRE AND SMOKE BARRIER - PROTECT ALL OPENINGS." (INCORPORATE CORRECT WALL DESIGNATIONS) FIRE WALLS SHALL BE STENCILED ON BOTH SIDES

### STAIR EGRESS CAPACITY

IBC 1005.3.1 AND NFPA 2012 - TABLE 7.3.3.1 CAPACITY FOR STAIRS IN A SPRINKLED BUILDING SHALL BE CALCULATED USING AN EGRESS CAPACITY FACTOR 0.3 INCH PER OCCUPANT

PER NFPA 2012 - 7.3.3.2, STAIRS GREATER THAN 44" ARE PERMITTED AN INCREASE USING THE EQUATION: C= 146.7 + ((Wn - 44) / 0.218)

STAIR TYPE	WIDTH OF STAIR	CAPACITY FACTOR	OCCUPANT CAPACITY
ST-1	7'-3"	NFPA FORMULA	344 OCCUPANTS
ST-2	4'-0"	NFPA FORMULA	165 OCCUPANTS

IBC 1005.3.1 AND NFPA 2012 - 7.3.1.4 - EXITS SERVING MORE THAN ONE STORY WHERE AN EXIT SERVES MORE THAN ONE STORY, ONLY THE OCCUPANT LOAD OF EACH STORY CONSIDERED INDIVIDUALLY SHALL BE USED IN COMPUTING THE REQUIRED CAPACITY OF THE EXIT AT THAT STORY

## PLUMBING FIXTURE COUNT

#### IPC 2012 EDITION 403.1.1 AND TABLE 403.1

THE AUDITORIUM WILL TYPICALLY HAVE A TOTAL MAXIMUM OCCUPANCY LOAD OF 1457. IPC REQUIRES A FIXTURE COUNT OF 1 WATER CLOSET (W.C.) PER 125 MALES OCCUPANTS AND 1 W.C. PER 65 FEMALE OCCUPANTS WITHIN AN A-1 ASSEMBLY USAGE. PER IPC 403.1.1 TOTAL OCCUPANT LOAD IS TO BE DIVIDED IN HALF TO GET A TOTAL OCCUPANT LOAD FOR EACH SEX

WATER CLOSETS (W.C.) 1457 OCCUPANTS / 2 = 729 MALES AND 729 FEMALES 729 OCCUPANTS /125 OCC. = 6 W.C. PER MALE

- IPC 419.2 - URINALS SHALL NOT BE SUBSTITUTED FOR MORE THAN 67 PERCENT OF THE REQUIRED WATER CLOSETS IN ASSEMBLY OCCUPANCY 729 OCCUPANTS / 65 OCC. = 12 W.C. PER FEMALE

PUBLICLY ACCESSIBLE W.C. IN FACILITY: FEMALES: 12 W.C.

MALES: 5 W.C. + 6 URINALS

**LAVATORY COUNTS** MIN. REQUIRED PER IPC IS 1 PER 200 OCCUPANTS 1457 OCCUPANTS / 200 OCC. = 8 LAVATORIES CURRENT PUBLICLY ACCESSIBLE LAVATORIES IN FACILITY: 9 MALES 9 FEMALES FACILITY EXCEEDS THE REQUIRED NUMBER OF LAVATORIES

**DRINKING FOUNTAINS** MIN. REQUIRED PER IPC IS 1 PER 500 OCCUPANTS

1457 OCCUPANTS / 500 OCC. = 3 D.F. CURRENT PUBLICLY ACCESSIBLE DRINKING FOUNTAINS IN FACILITY: 4 D.F. FACILITY MEETS THE REQUIRED NUMBER OF DRINKING FOUNTAINS

MIN. REQUIRED PER IPC IS 1 TOTAL CURRENT SERVICE SINKS IN FACILITY:

### BUILDING CODE ANALYSIS

LISTED BELOW ARE THE REGULATORY REQUIREMENTS THAT APPLY TO THIS PROJECT REFER TO SECTION 01 41 14 REGULATORY REQUIREMENTS. THIS LIST IS PROVIDED AS A CONVENIENCE TO THE CONTRACTOR AND IS NOT TO BE CONSIDERED ALL INCLUSIVE OF CODES AND REGULATIONS THAT MAY APPLY. THE CONTRACTOR SHALL COMPLY WITH ALL PERTINENT CODES, STANDARDS, REGULATIONS AND LAWS.

(A) INTERNATIONAL BUILDING CODE (IBC), 2012 EDITION, PUBLISHED BY THE INTERNATIONAL CODE COUNCIL (ICC), EXCEPT FOR:

1. CHAPTER 11 ACCESSIBILITY; AND, 2. CHAPTER 34, SECTION 3411 ACCESSIBILITY FOR EXISTING BUILDINGS; (B) THE INTERNATIONAL FUEL GAS CODE (IFGC), 2012 EDITION, PUBLISHED BY THE INTERNATIONAL CODE COUNCIL (ICC);

(C) THE INTERNATIONAL MECHANICAL CODE (IMC), 2012 EDITION, PUBLISHED BY THE INTERNATIONAL CODE COUNCIL (ICC); (D) THE INTERNATIONAL PLUMBING CODE (IPC), 2012 EDITION, PUBLISHED BY THE INTERNATIONAL CODE COUNCIL (ICC); (E) THE INTERNATIONAL PROPERTY MAINTENANCE CODE (IPMC), 2012 EDITION

PUBLISHED BY THE INTERNATIONAL CODE COUNCIL (ICC); (F) THE INTERNATIONAL FIRE CODE (IFC), 2012 EDITION, PUBLISHED BY TH INTERNATIONAL CODE COUNCIL (ICC); (G) THE INTERNATIONAL ENERGY CONSERVATION CODE (IECC), 2012 EDITION, PUBLISHED BY THE INTERNATIONAL CODE COUNCIL (ICC), EXCEPT THAT THE PROVISIONS OF THE

INTERNATIONAL ENERGY CONSERVATION CODE, 2009 EDITION, SHALL APPLY TO THI FOLLOWING OCCUPANCY CLASSIFICATIONS AS DEFINED BY THE INTERNATIONAL BUILDING 1. MODERATE-HAZARD FACTORY INDUSTRIAL, GROUP F-1;

2. LOW-HAZARD FACTORY INDUSTRIAL, GROUP F-2; 3. MODERATE-HAZARD STORAGE, GROUP S-1; AND,

4. LOW-HAZARD STORAGE, GROUP S-2; THE INTERNATIONAL EXISTING BUILDING CODE (IEBC), 2012 EDITION, PUBLISHED BY THE INTERNATIONAL CODE COUNCIL (ICC); (I) FOR STATE BUILDINGS, EDUCATIONAL OCCUPANCIES AND ANY OTHER OCCUPANCY REQUIRING AN INSPECTION BY THE STATE FIRE MARSHAL FOR INITIAL LICENSURE, NFPA

LIFE SAFETY CODE, 2012 EDITION, PUBLISHED BY THE NATIONAL FIRE PROTECTION ASSOCIATION (NFPA); (J) NO PROVISION OF THE PRECEDING CITED PUBLICATIONS SHALL BE ADOPTED THAT

2. THE STANDARDS FOR ENGAGING IN THE LIQUEFIED PETROLEUM GAS BUSINESS IN TENN. COMP. R. & REGS. 0780-02-17-.02 (K) NATIONAL ELECTRIC CODE, NFPA 70, 2017 EDITION, PUBLISHED BY THE NATIONAL FIRE PROTECTION ASSOCIATION (L) TENNESSEE PUBLIC BUILDING ACCESSIBILITY ACT 2010 ADA STANDARDS FOR

II. OCCUPANCY CLASSIFICATION ASSEMBLY - ASSEMBLY GROUP A-1

#### II-B, SPRINKLERED (IBC TABLES 503/601)

MAX ALLOWABLE HEIGHT: 55 FEET + 20 FEET (IBC 504.2) = 75 FEET TOTAL MAX ALLOWABLE STORIES: 2 STORIES + 1 STORY FOR SPRINKLER (IBC 504.2)

**ACTUAL HEIGHT: 32 FEET ACTUAL STORIES: 1 STORY** 

12.3.2.1.2(2) AND 12.4.5.4.1

V. FIRE PREVENTION & EGRESS FIRE RESISTIVE / CONSTRUCTION REQUIREMENTS (IBC TABLE 601)

TYPE II-B 0 HOURS BEARING WALLS - EXTERIOR: **BEARING WALLS - INTERIOR** FLOOR CONSTRUCTION: 0 HOURS 0 HOURS **ROOF CONSTRUCTION:** 


FIRE PROTECTION CORRIDOR SEPARATION (W/ SPRINKLER): 0 HOURS (IBC TABLE 1018.1


STAGE HEIGHT IS 30'-10" PER IBC 410.3.1.1. SINCE THE STAGE HEIGHT IS UNDER 50', THE PROSCENIUM WALL DOES NOT NEED TO BE RATED PER IBC 410.3.4 AND NFPA 12.4.5.6.4 - BECAUSE THE PROSCENIUM WALL DOES NOT NEED TO BE RATED, THE STAGE OPENING

STAGE IS MORE THAN 1000 SQ. FEET (3,651 SF) SO IT REQUIRES EMERGENCY VENTILATION PER IBC 410.3.7 - COORDINATE WITH M,P, & E DRAWINGS.

DRESSING ROOMS, SCENE DOCKS, WORKSHOPS AND STOREROOMS SHALL BE SEPARATED FROM THE STAGE BY 1-HOUR WALL FOR STAGE HEIGHT LESS THAN 50 FEET PER IBC 410.5.1 AND NFPA 12.3.2.1.2(2) AND 12.4.5.4.1. DRESSING ROOMS, SCENE DOCKS, PROPERTY ROOMS, WORKSHOPS, STOREROOMS SHALL BE SEPARATED FROM EACH OTHER BY 1-HOUR FIRE BARRIER PER IBC 410.5.1 AND NFPA

AREAS OF REFUGE AREAS OF REFUGE ARE NOT REQUIRED AT STAIRWAYS IN BUILDINGS EQUIPPED THROUGHOUT WITH AN AUTOMATIC SPRINKLER SYSTEM (IBC 1007.3, EXCEPTION 2)

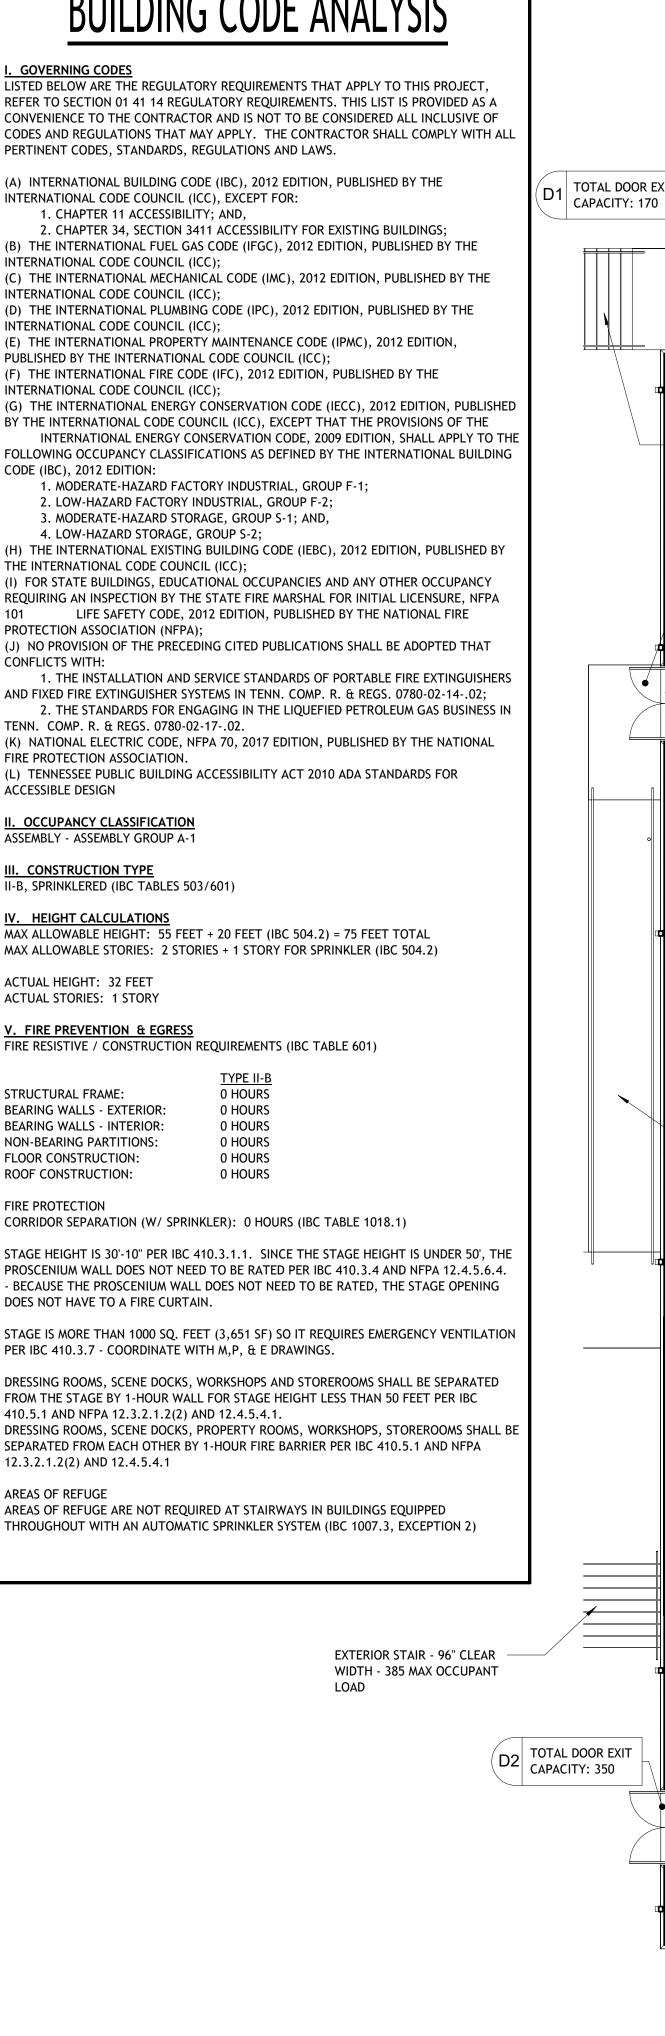

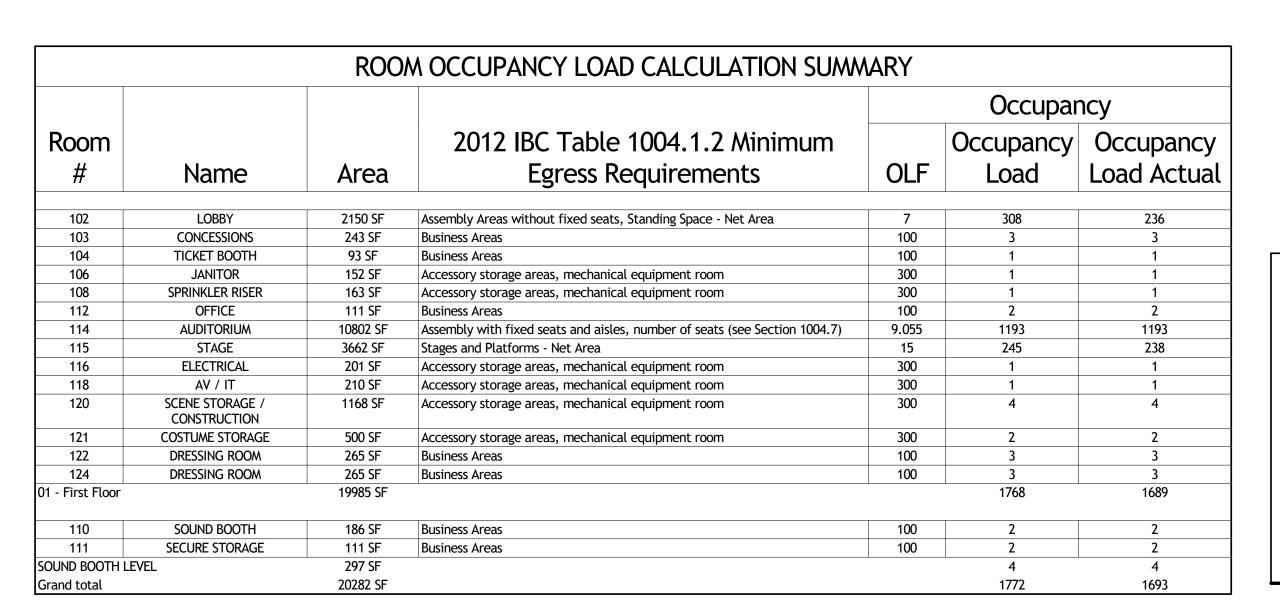



# MAXIMUM TRAVEL DISTANCE


NFPA 2012 EDITION 12.2.6 AND IBC 2012 EDITION TABLE 1016.2 ALLOWABLE EXIT TRAVEL DISTANCE FOR A NEW ASSEMBLY OCCUPANCY WITH A SPRINKLER SYSTEM = 250 FEET

TWO HIGHEST TRAVEL DISTANCES WITH A SPRINKLER ARE DISTANCES OF 108'-10" AND 102'-2", WHICH ARE UNDER THE ALLOWABLE DISTANCE OF 250

DEAD END CORRIDOR REQUIREMENTS - IBC 2012 - 1018.1 AND NFPA 12.2.5.1.3 (NEW ASSEMBLY OCCUPANCY): 20 FEET

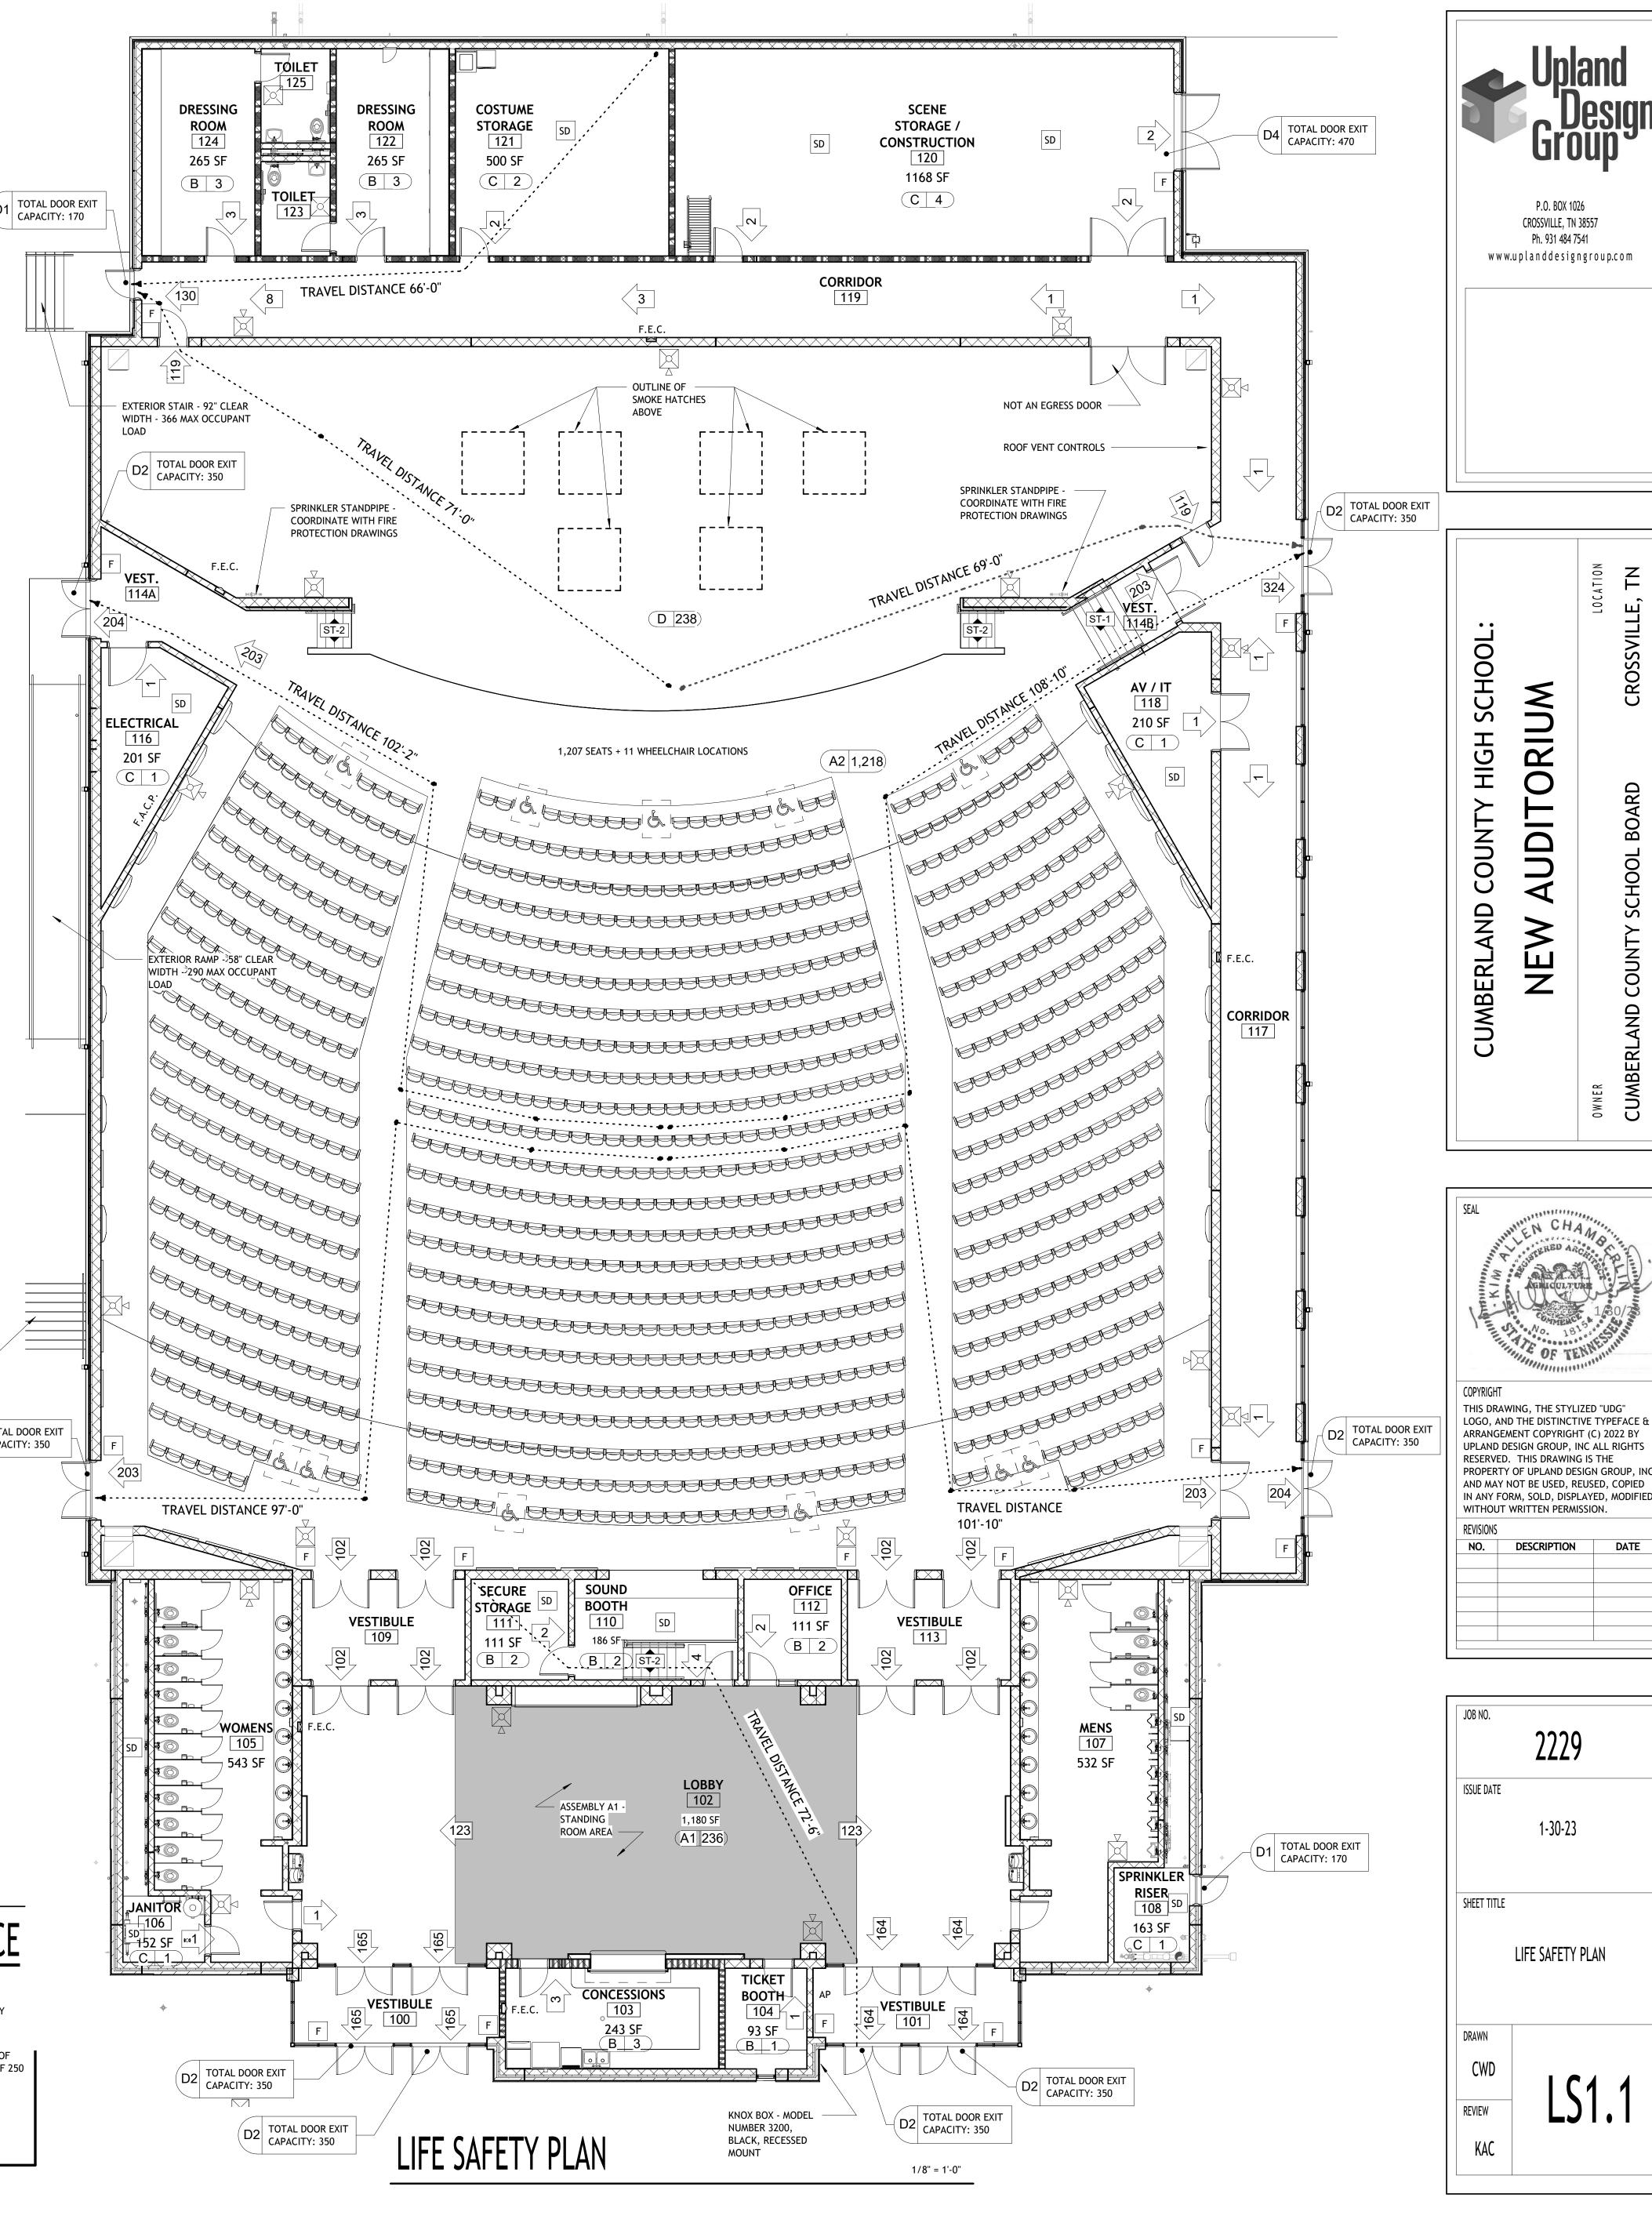

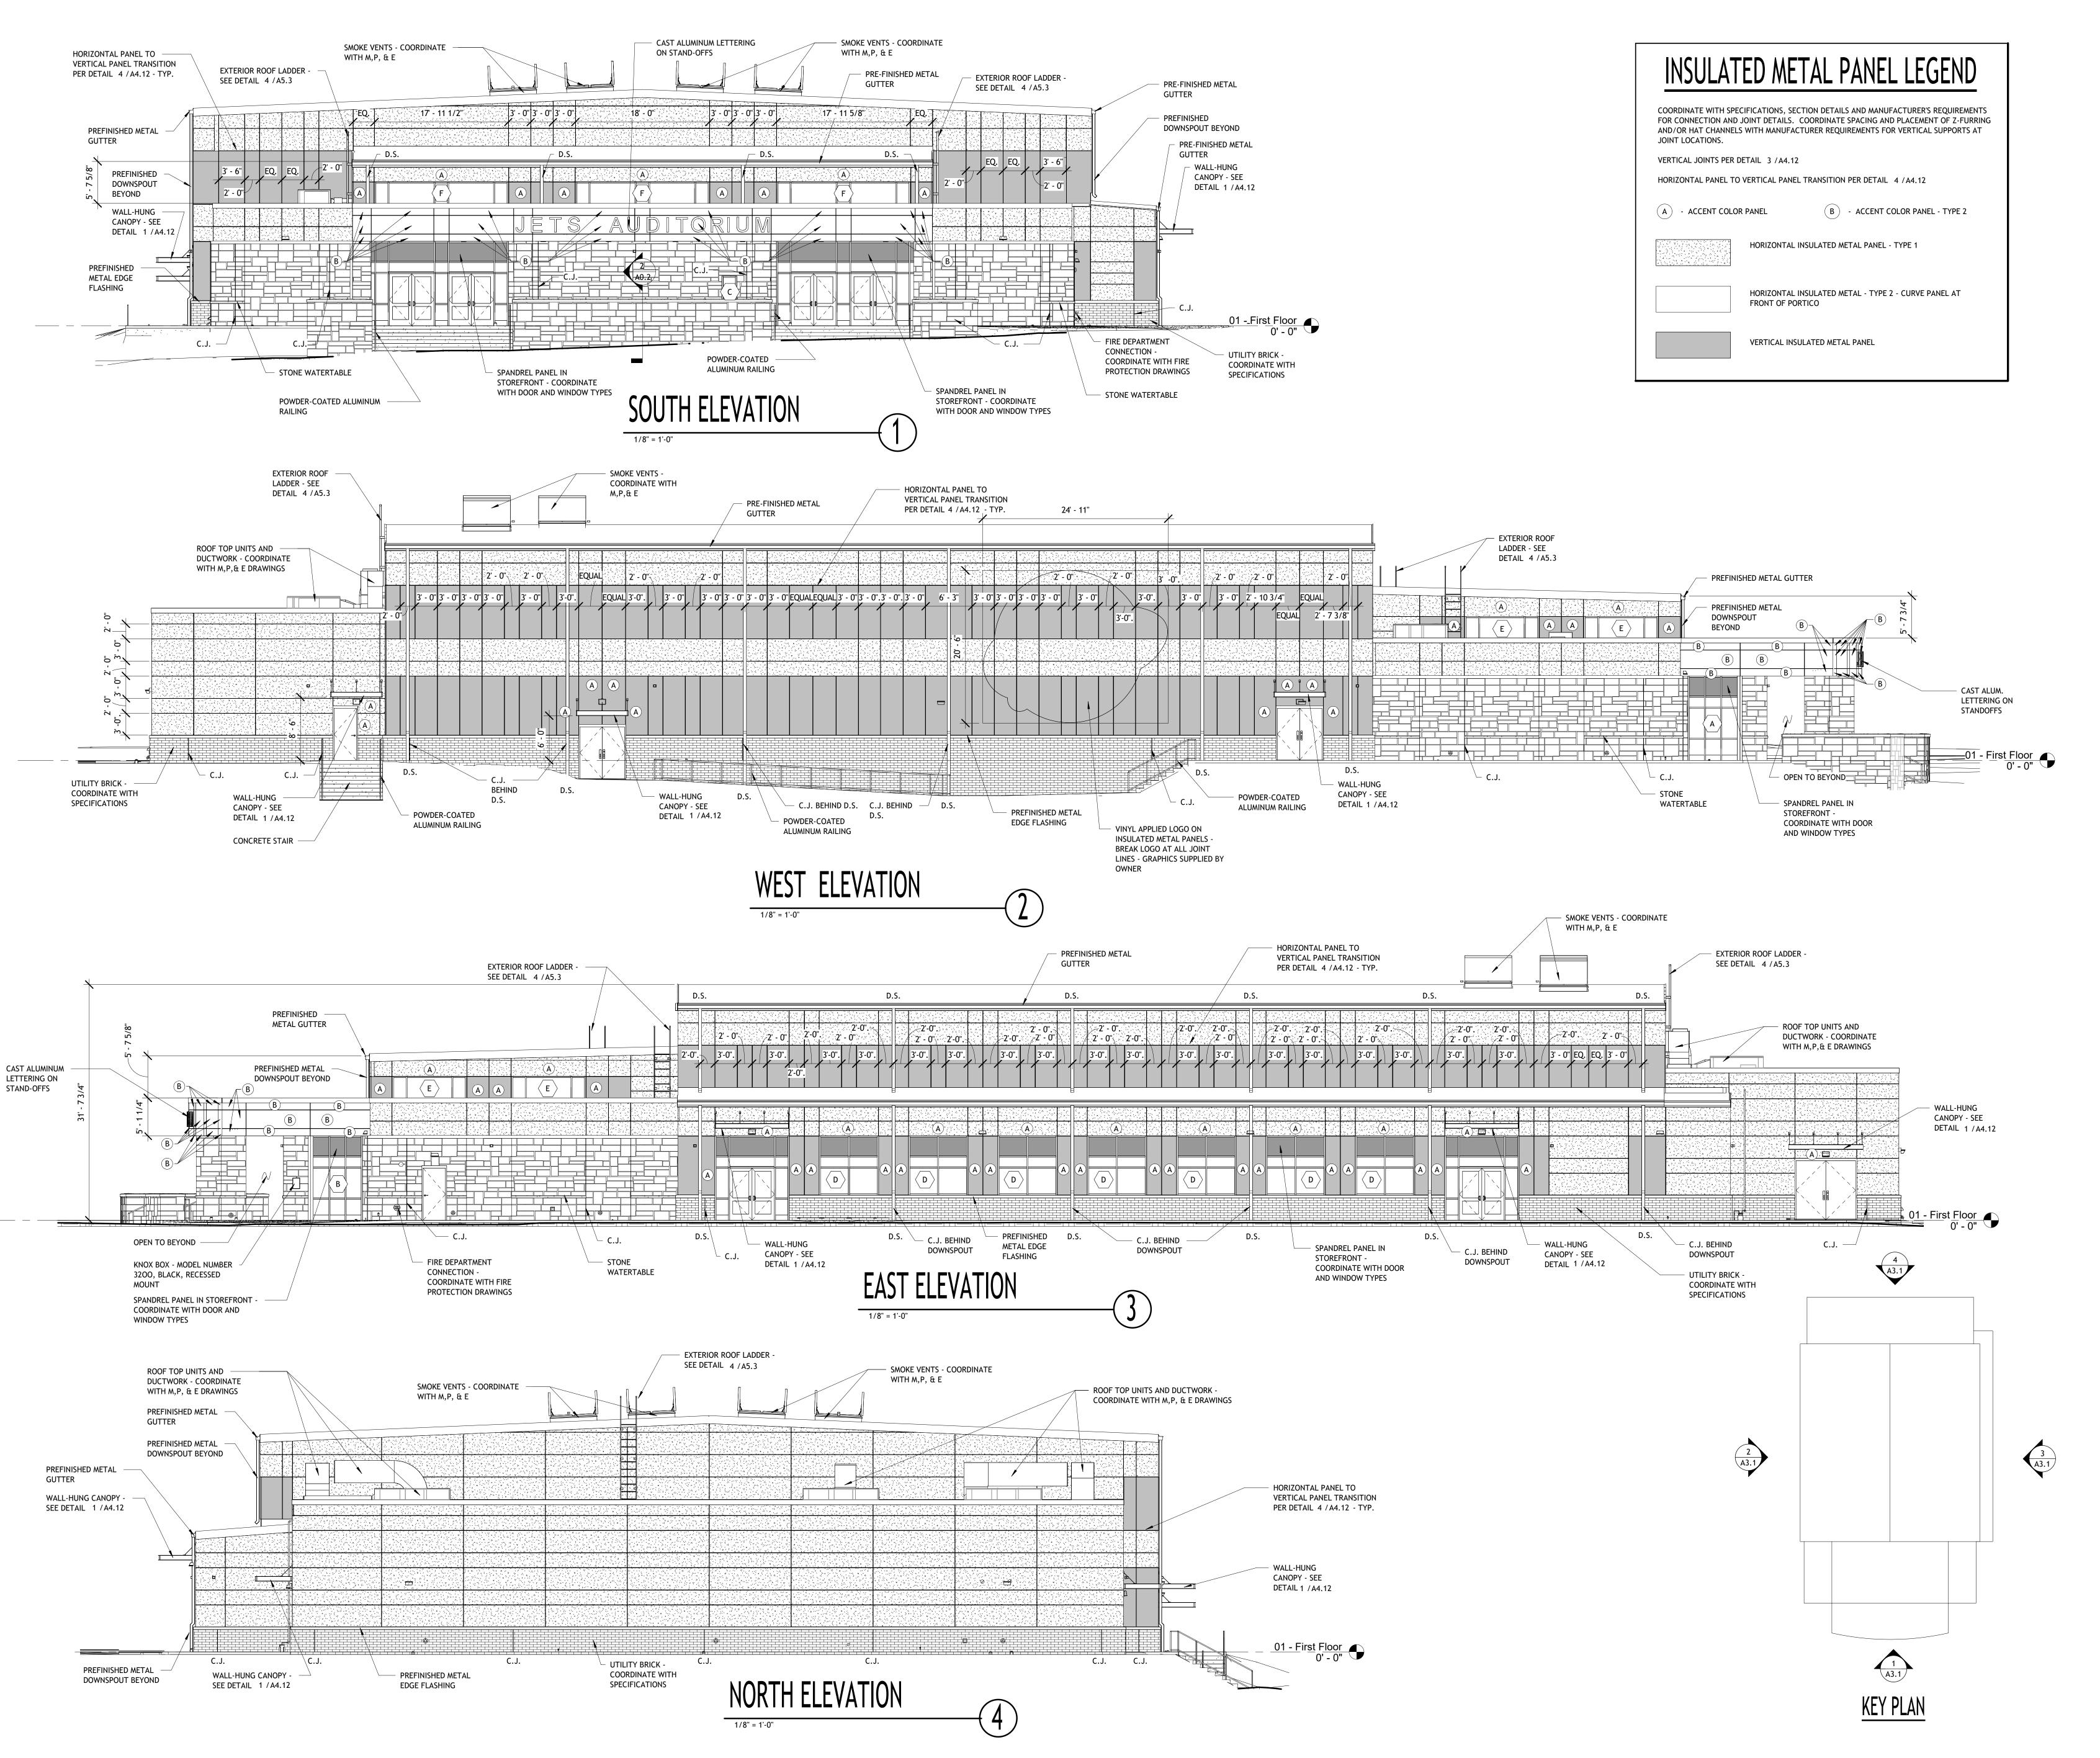

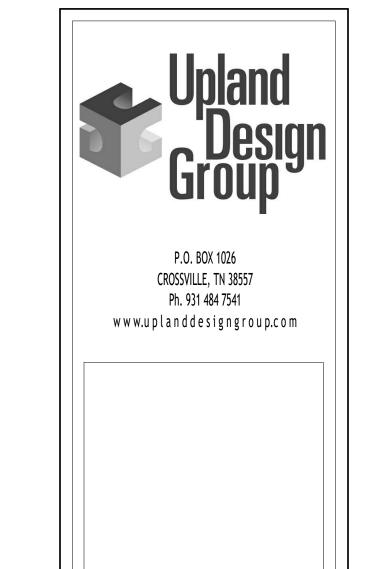

CUMBERLAND COUNTY HIGH SCHOOL:

NEW AUDITORIUM

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REVISIONS

NO. DESCRIPTION DATE

JOB NO.

2229

ISSUE DATE

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SHEET TITLE


EXTERIOR ELEVATIONS


CWD

REVIEW


KAC

A3.1

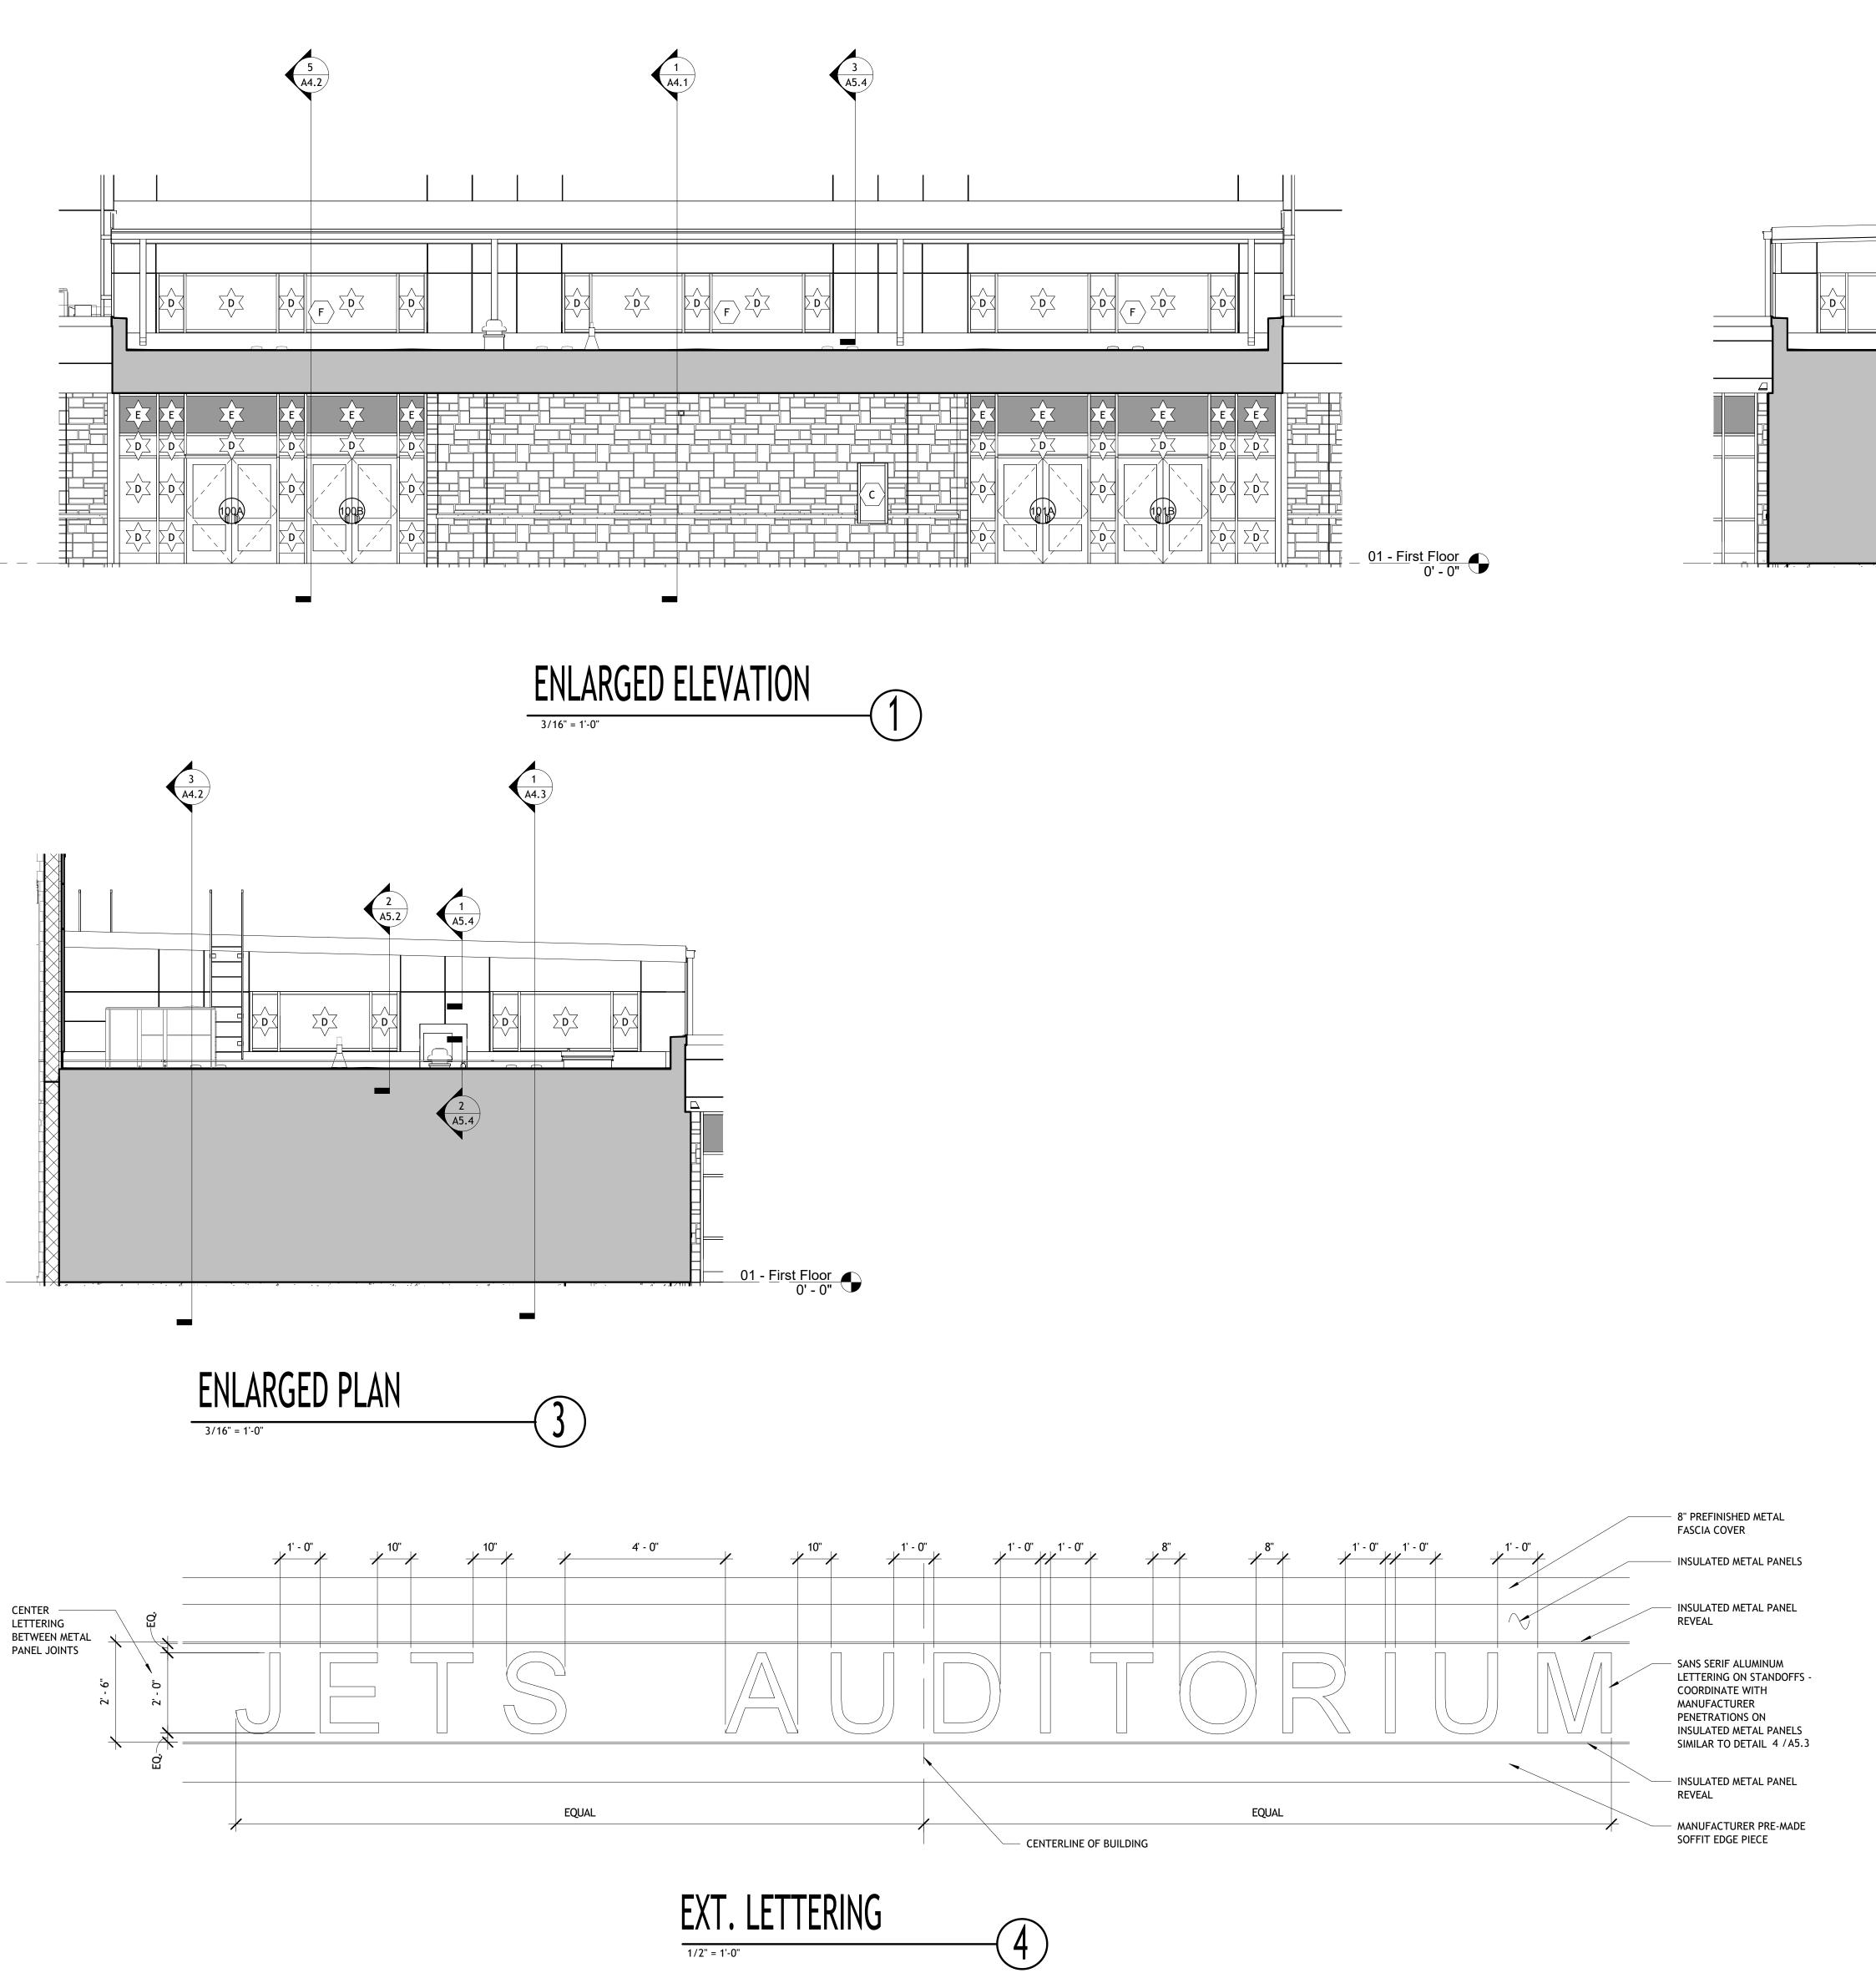

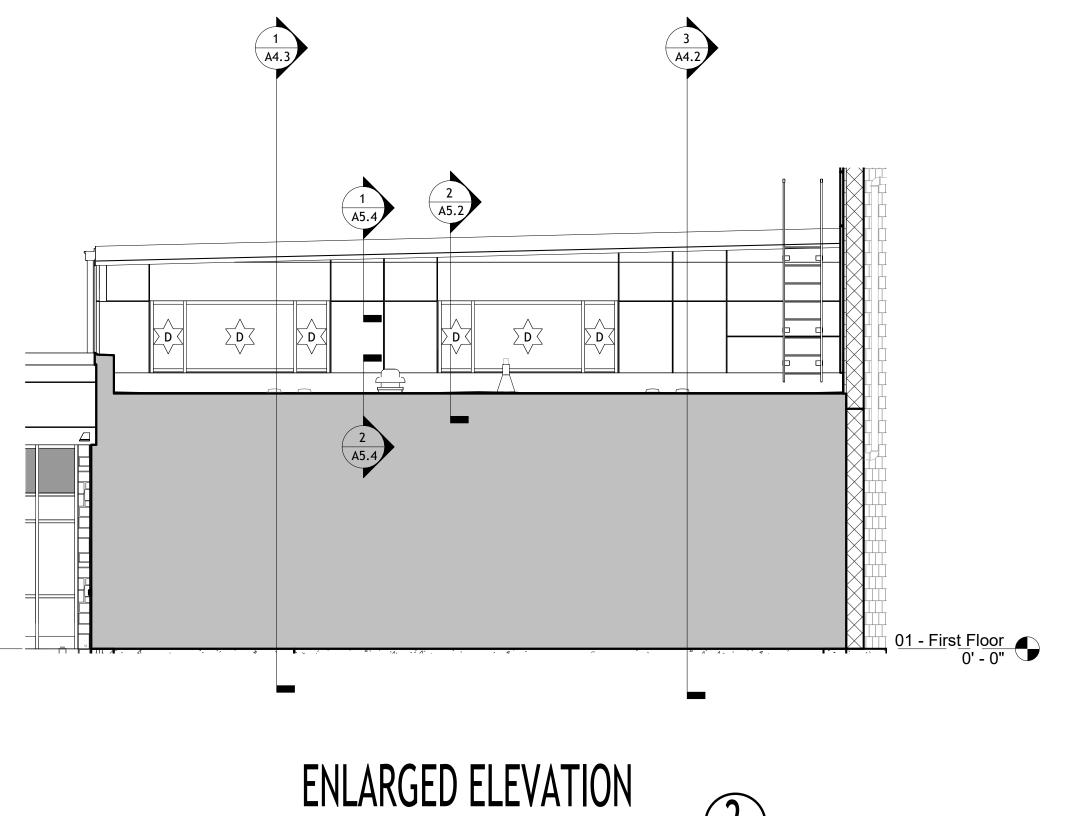

3/16" = 1'-0"

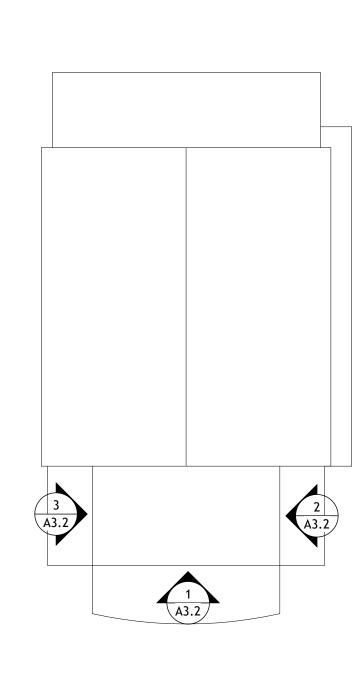

KEY PLAN



P.O. BOX 1026 CROSSVILLE, TN 38557 Ph. 931 484 7541

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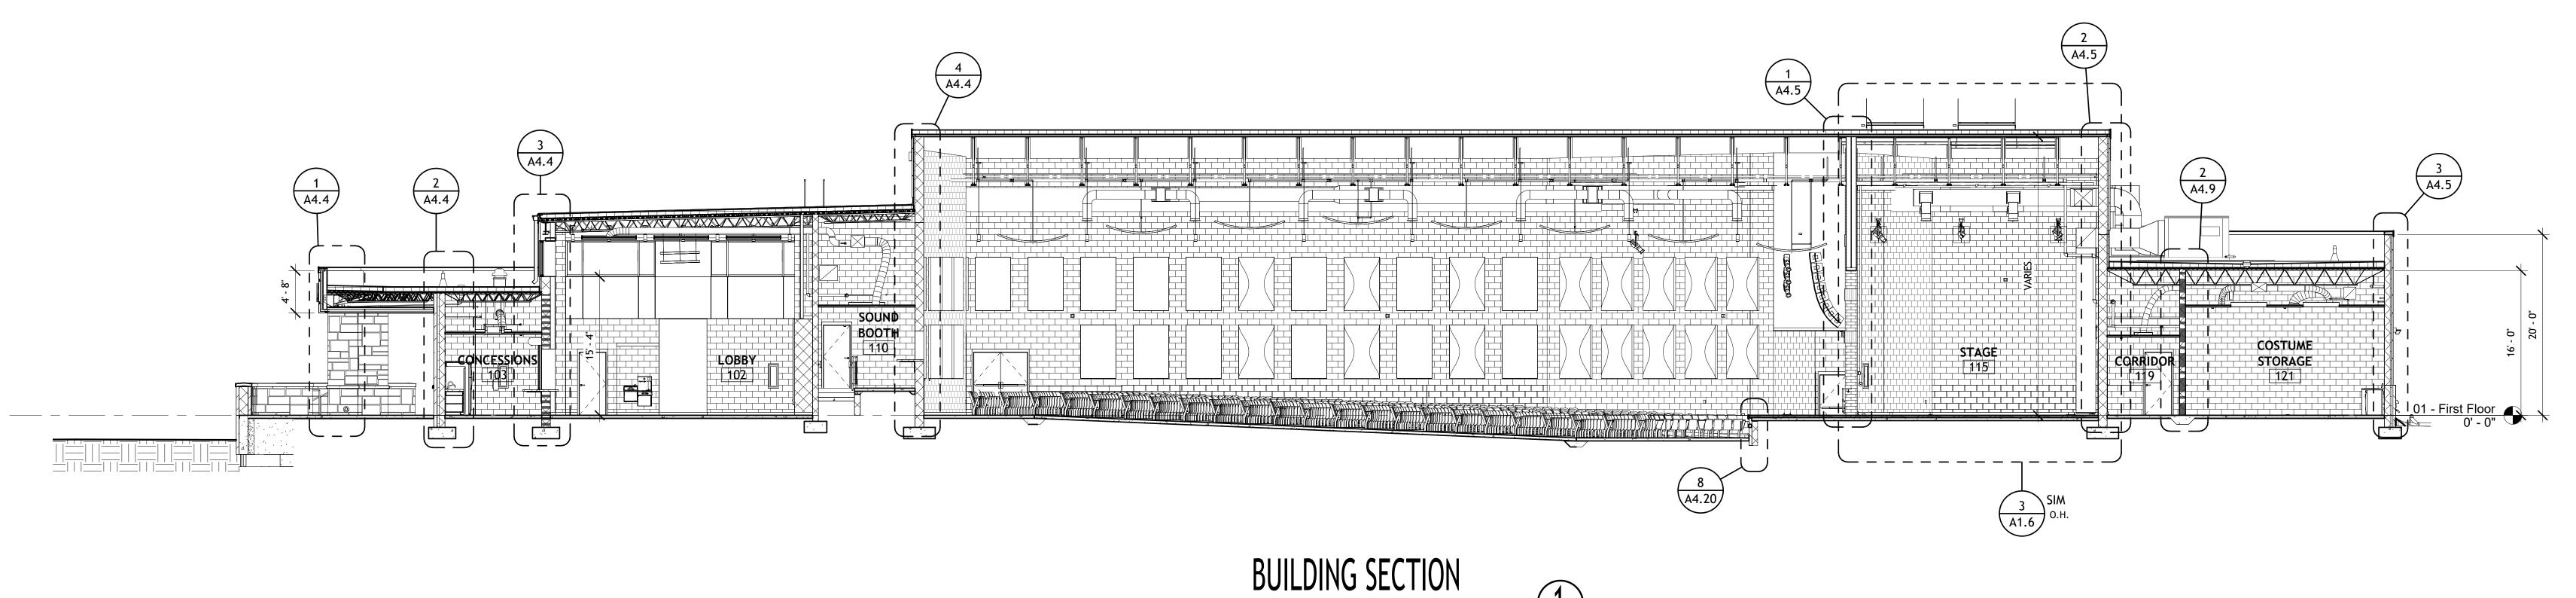
THOUT WRITTEN PERMISSION.				
VISIONS				
10.	DESCRIPTION	DATE		


ISSUE DATE

1-30-23


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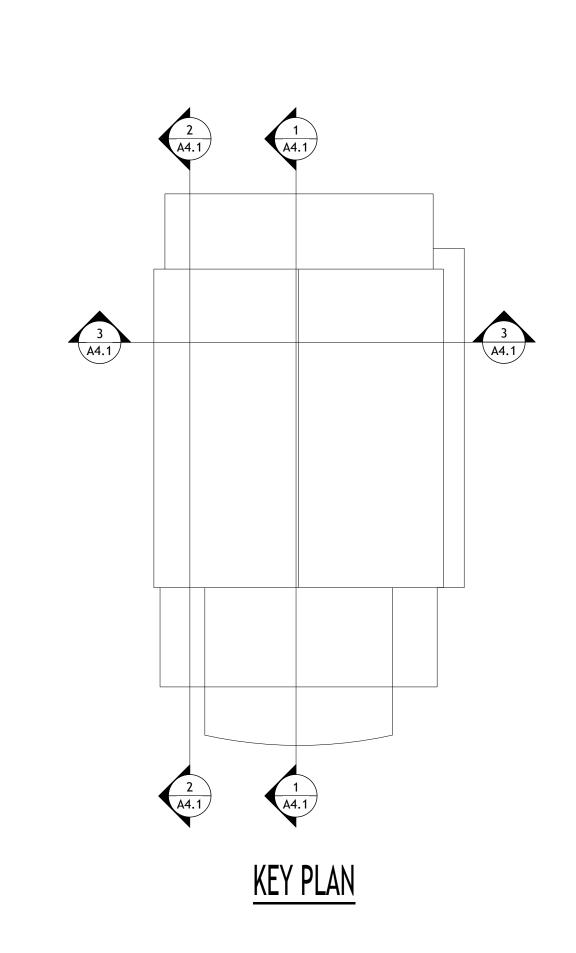
REVIEW





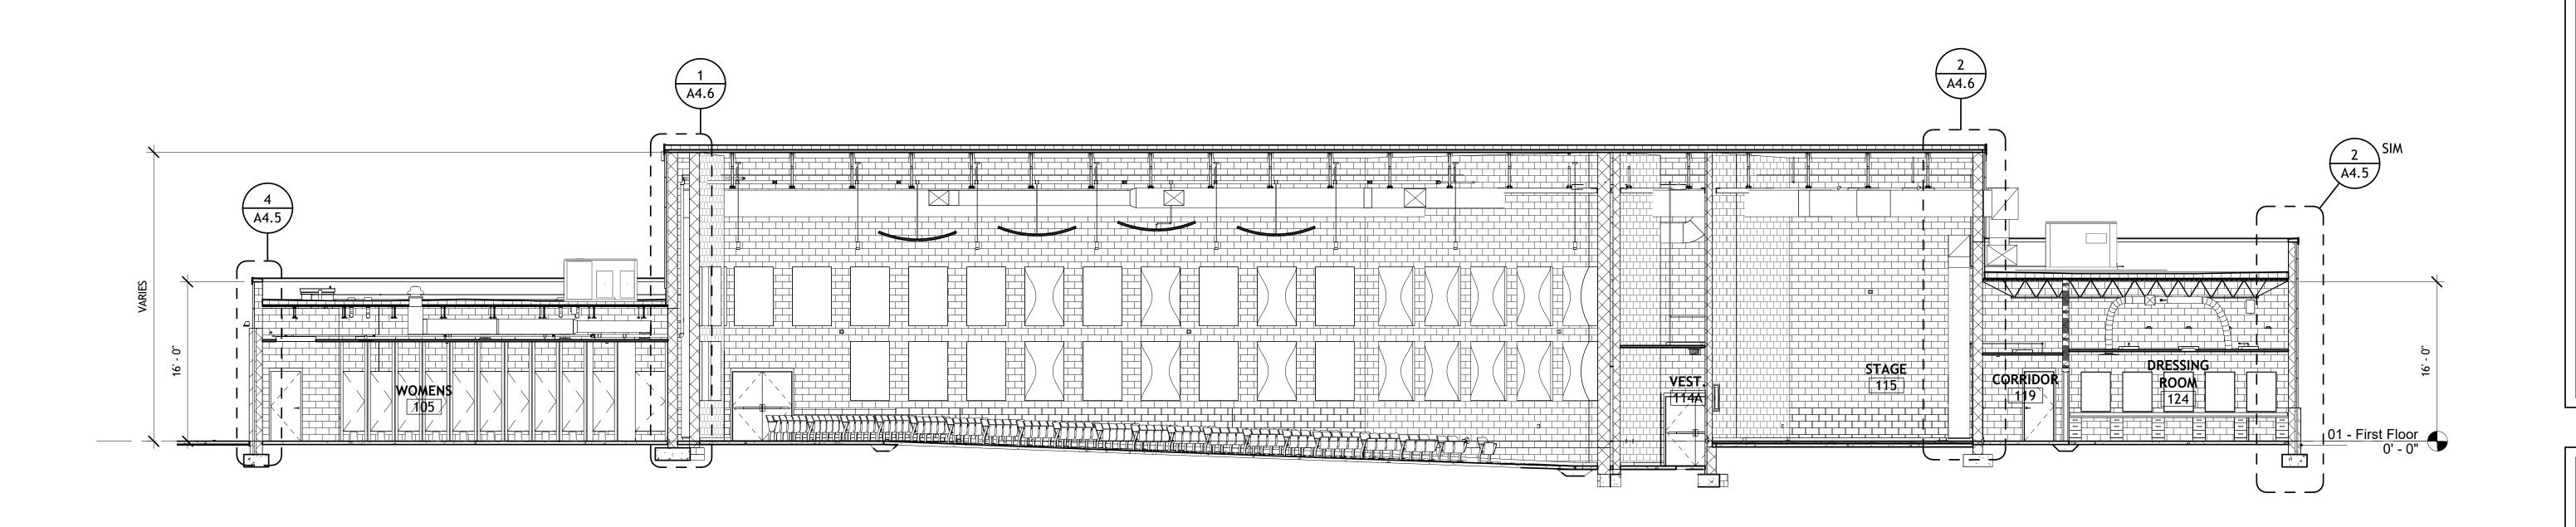



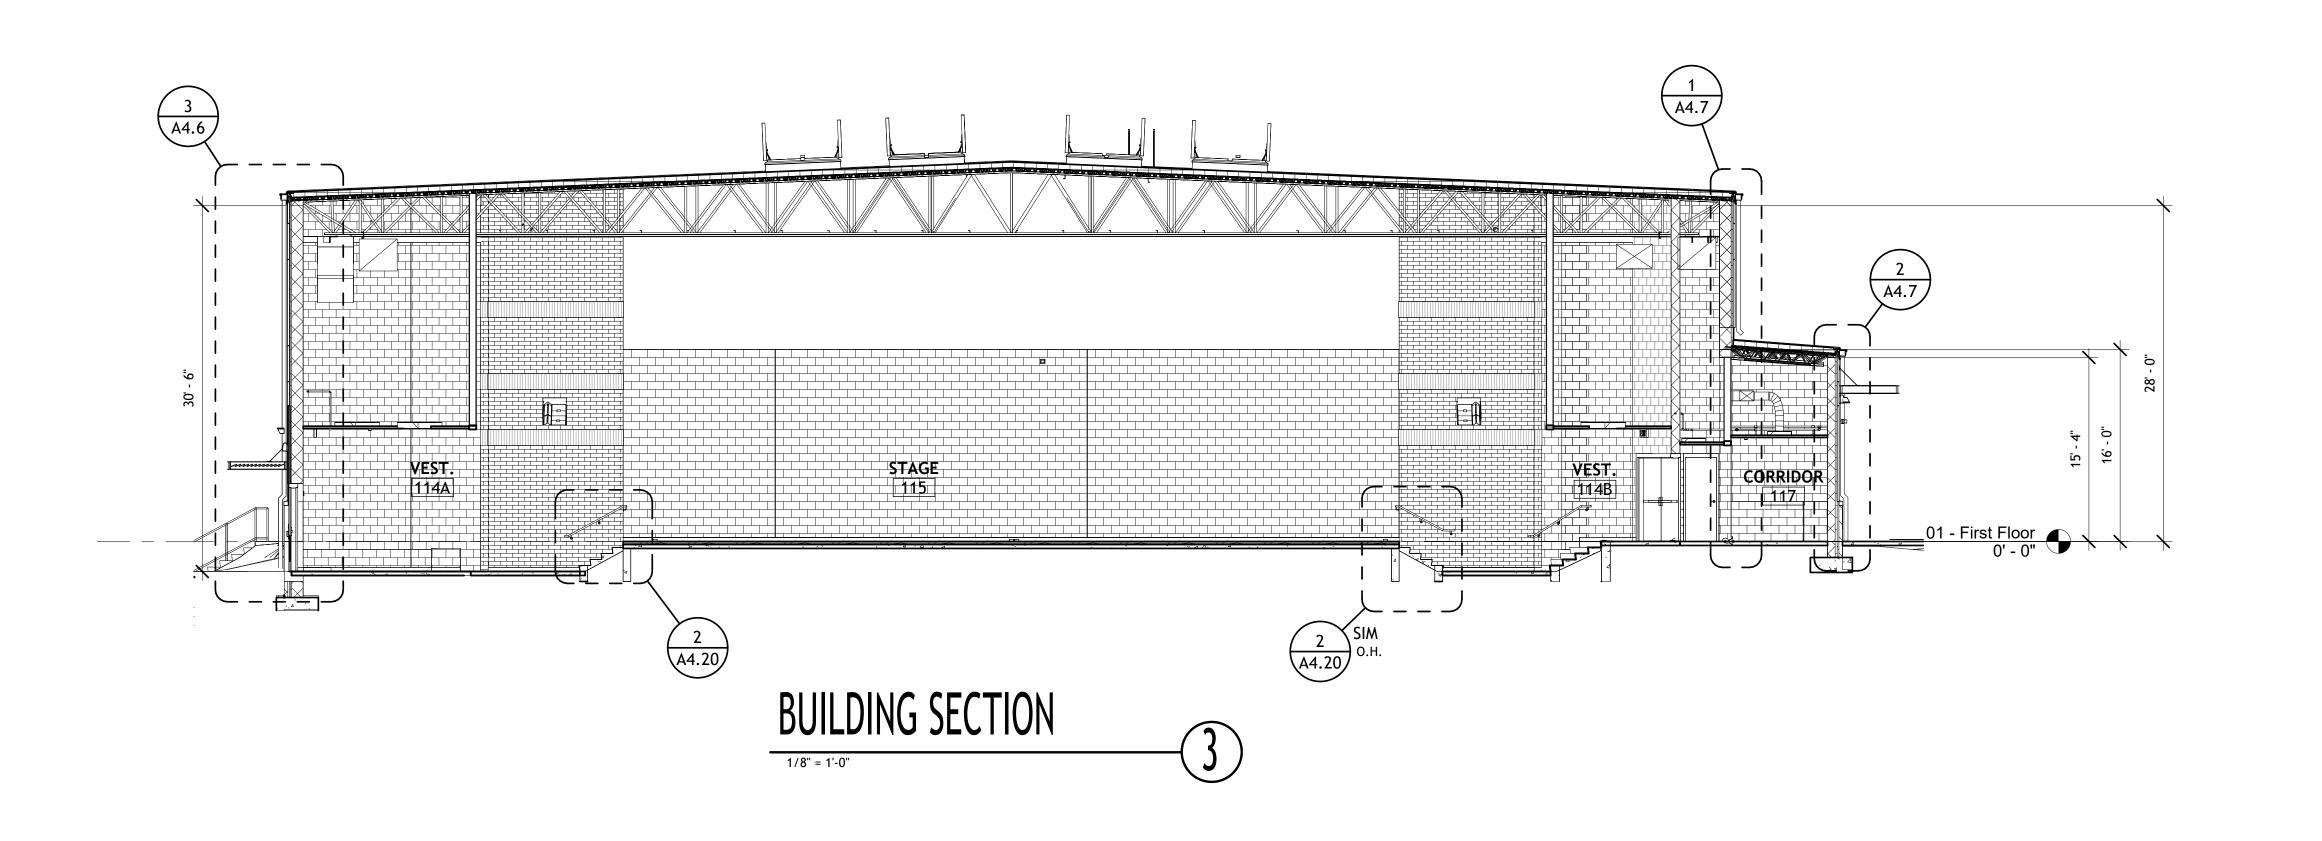




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REVISIONS		
NO.	DESCRIPTION	DATE


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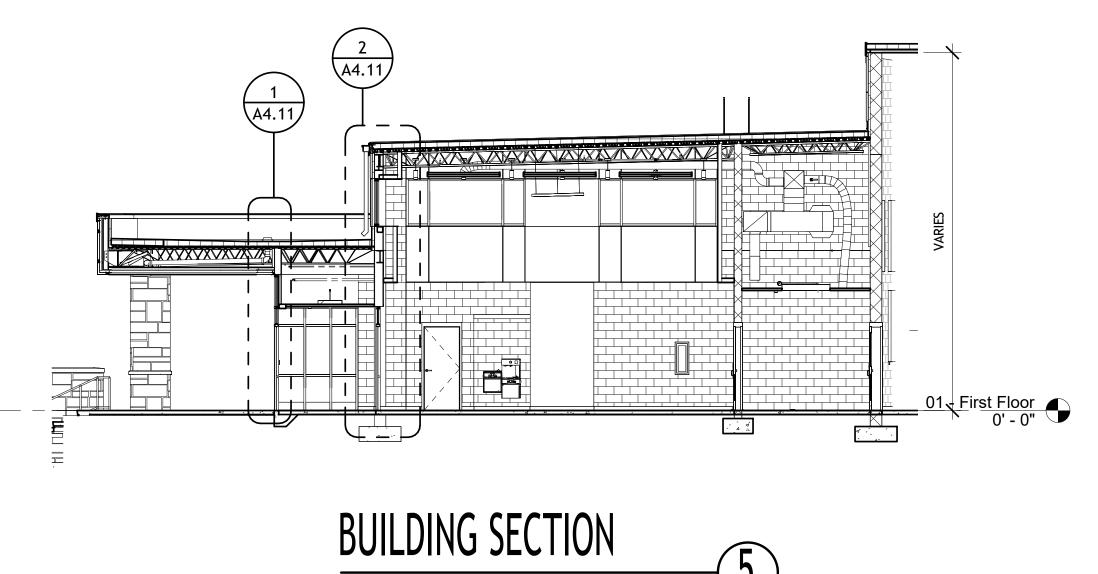
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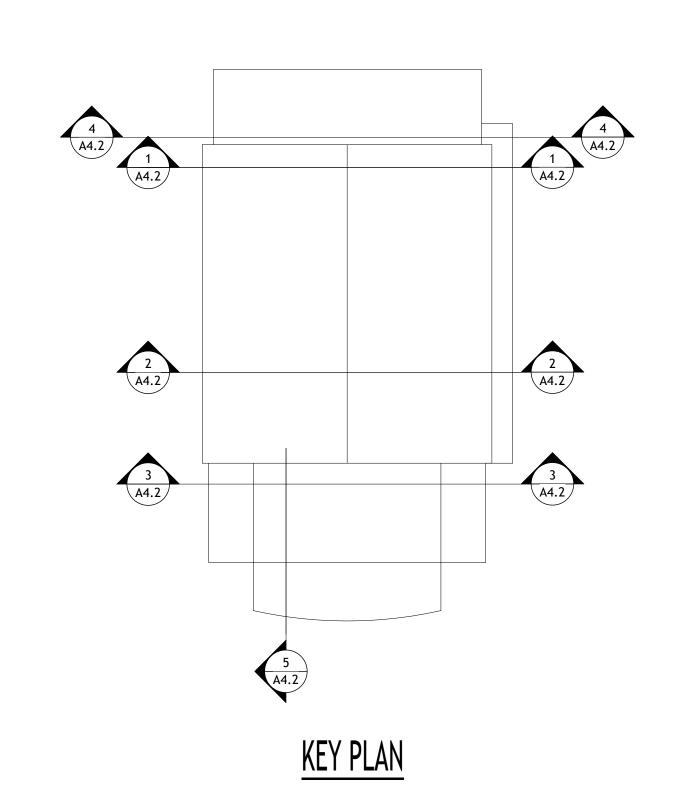
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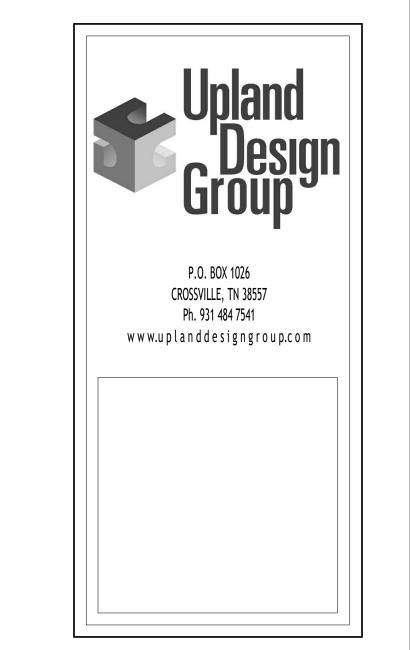
CWD REVIEW

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JOB NO.

2229

ISSUE DATE

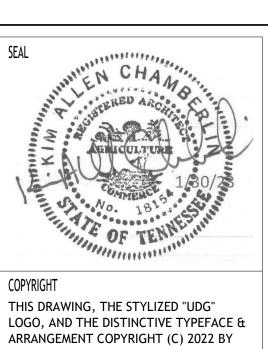
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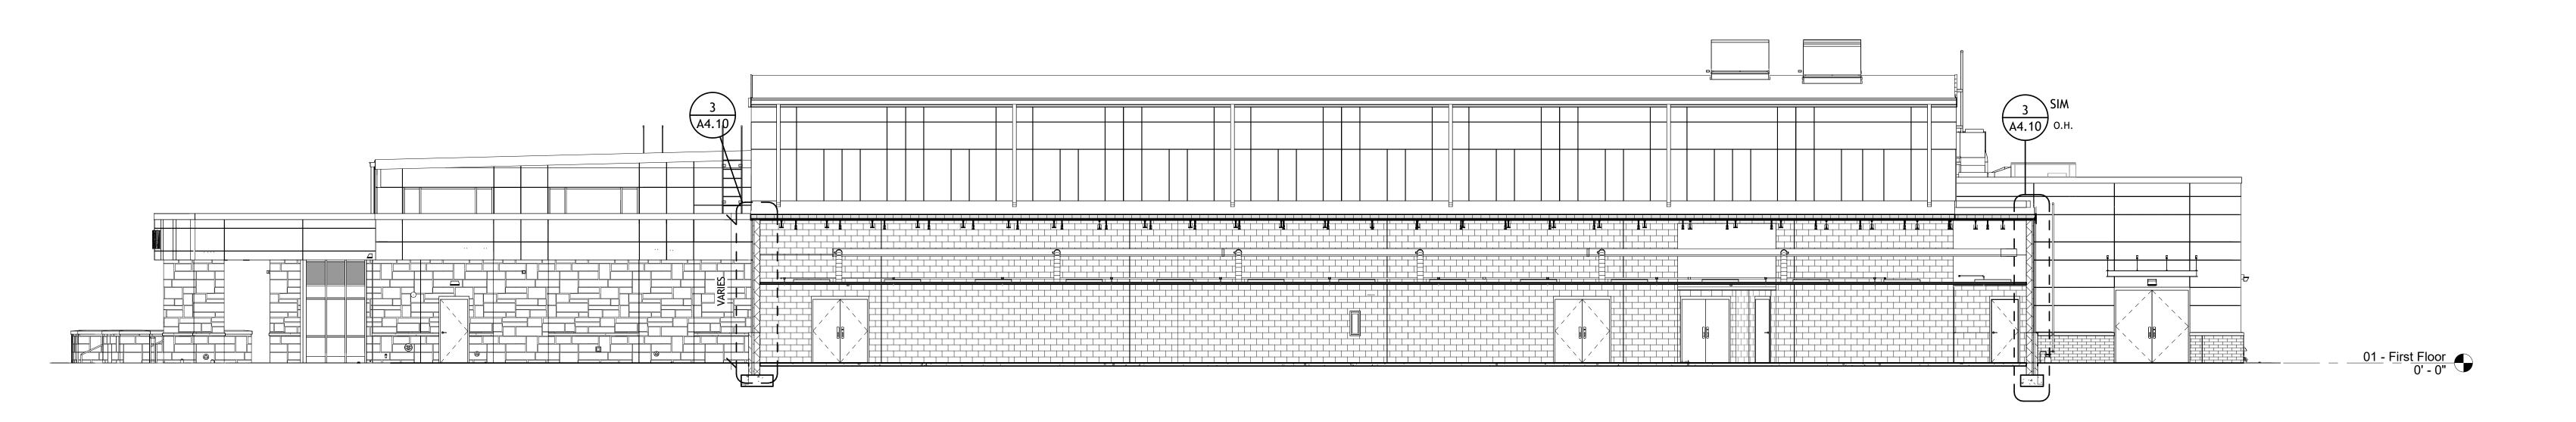
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BUILDING SECTIONS

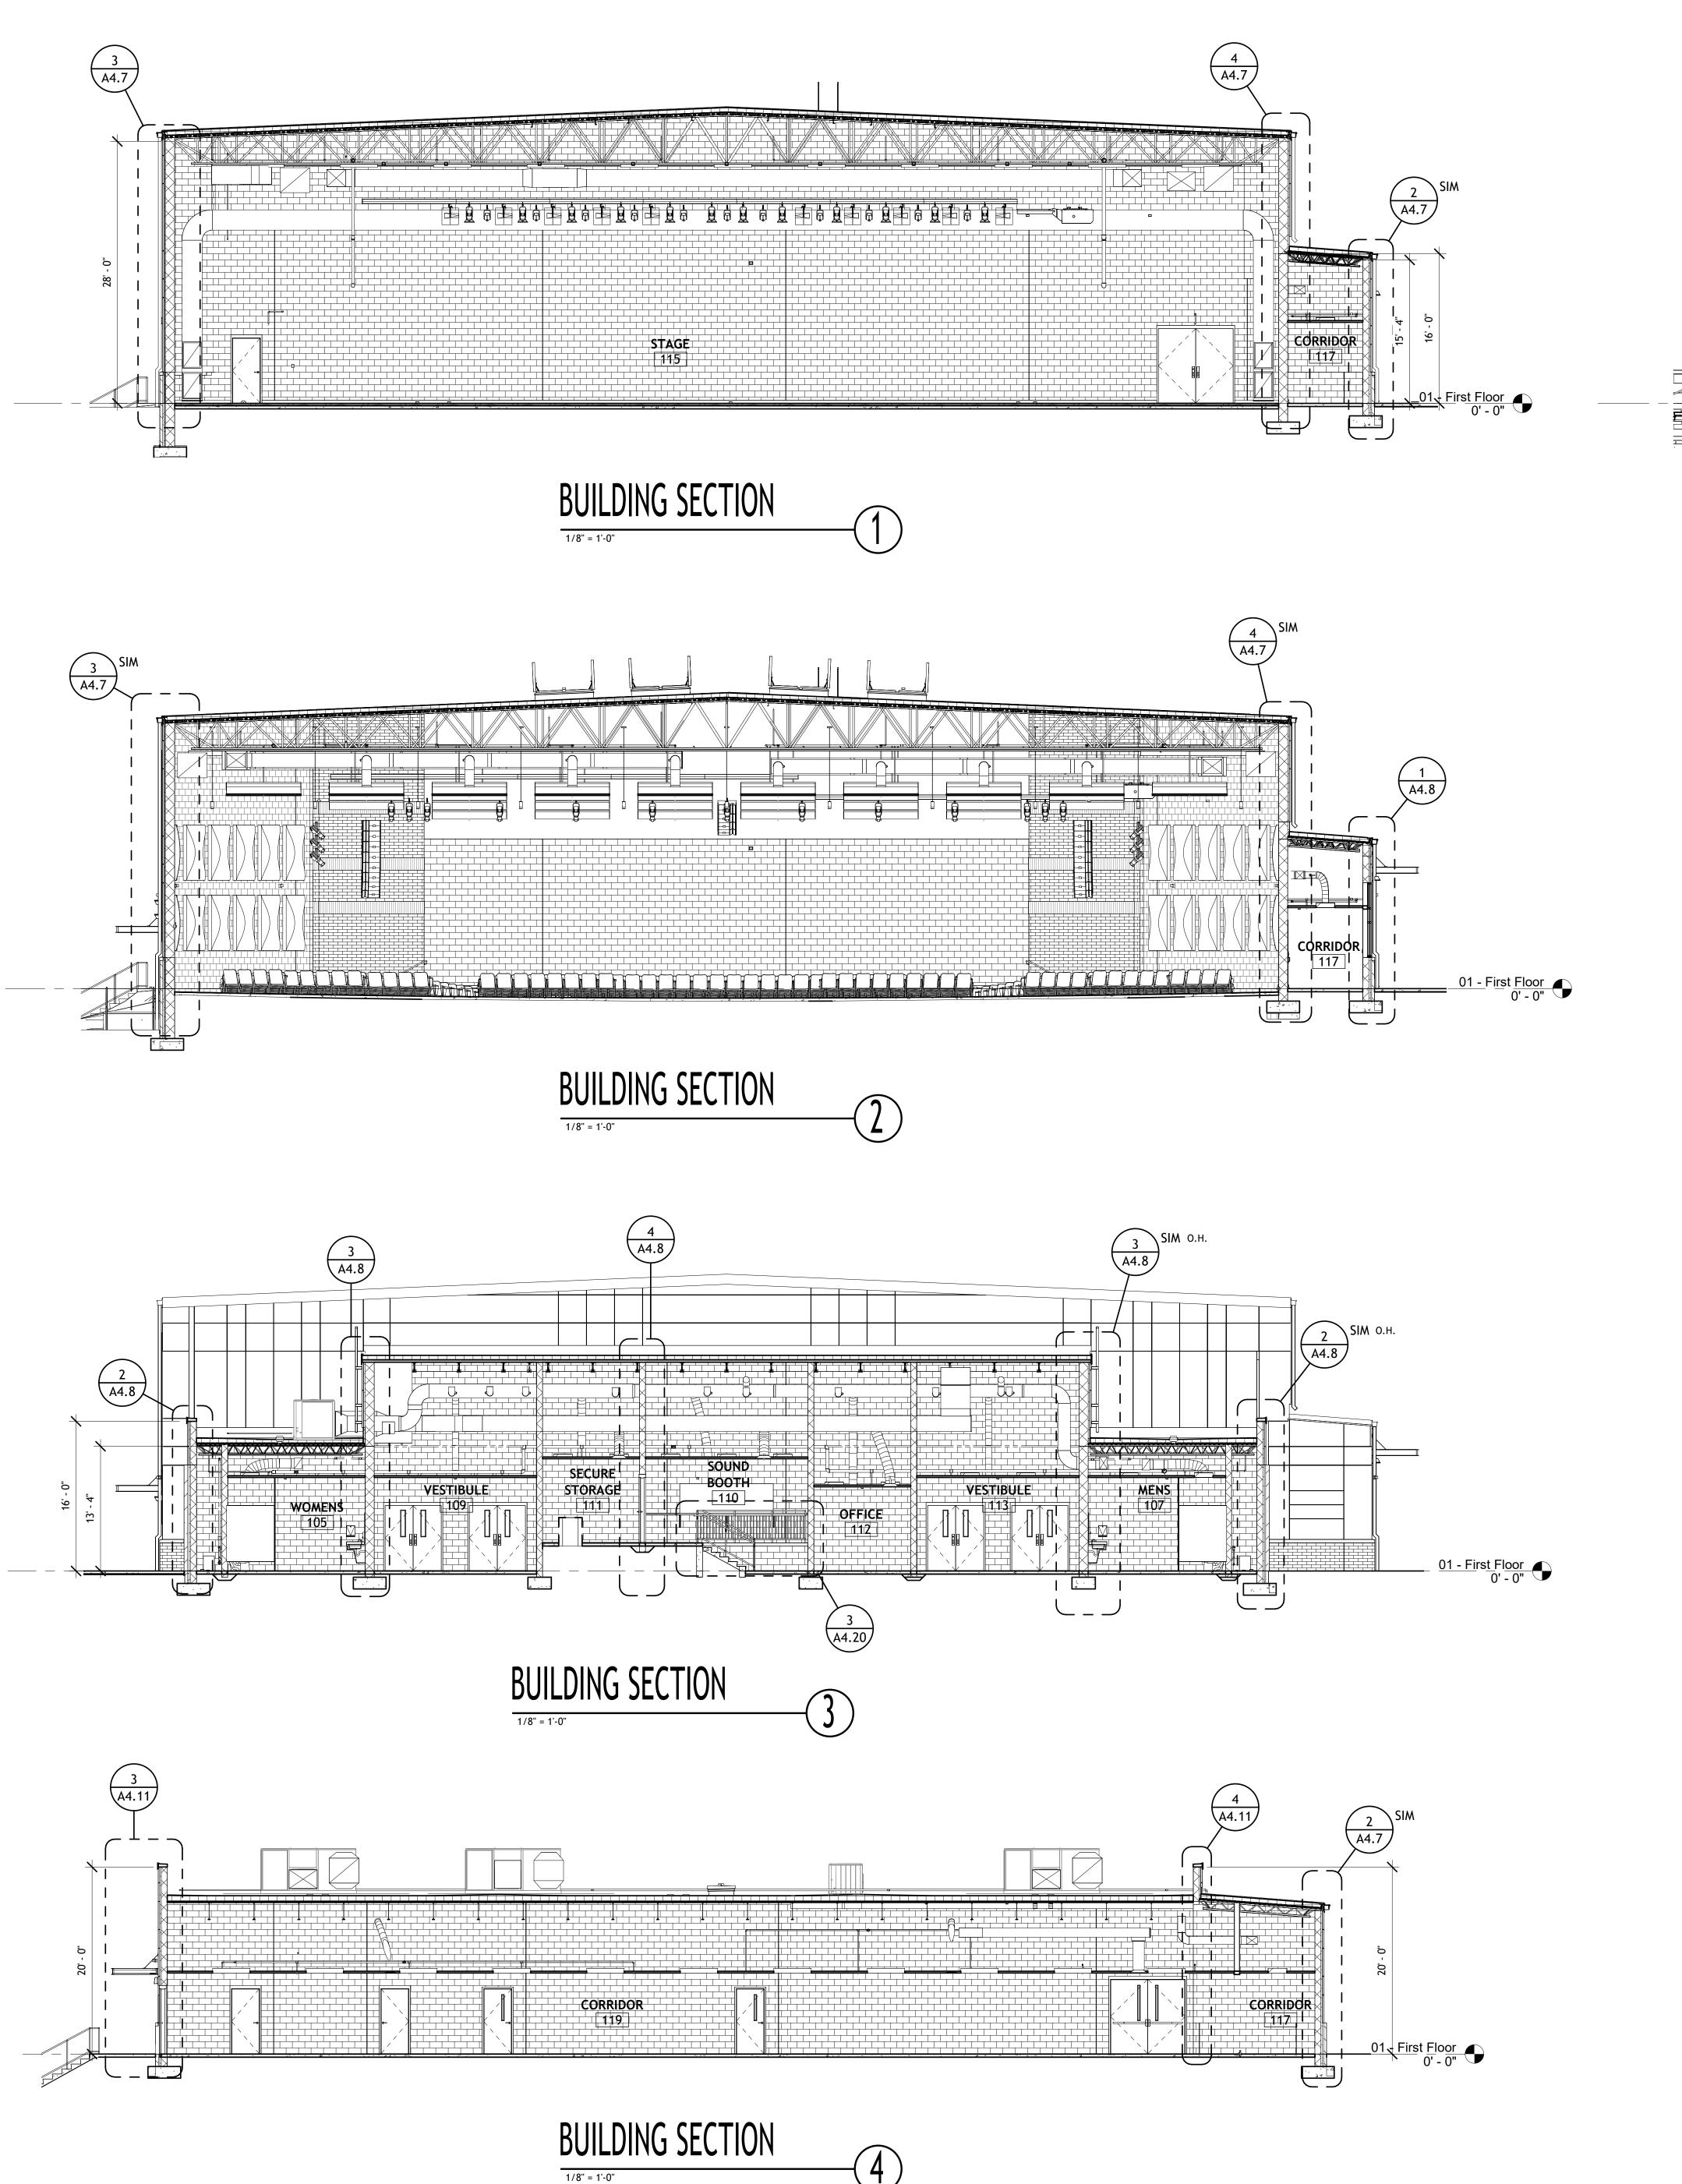
DRAWN
CWD
REVIEW

A4.2






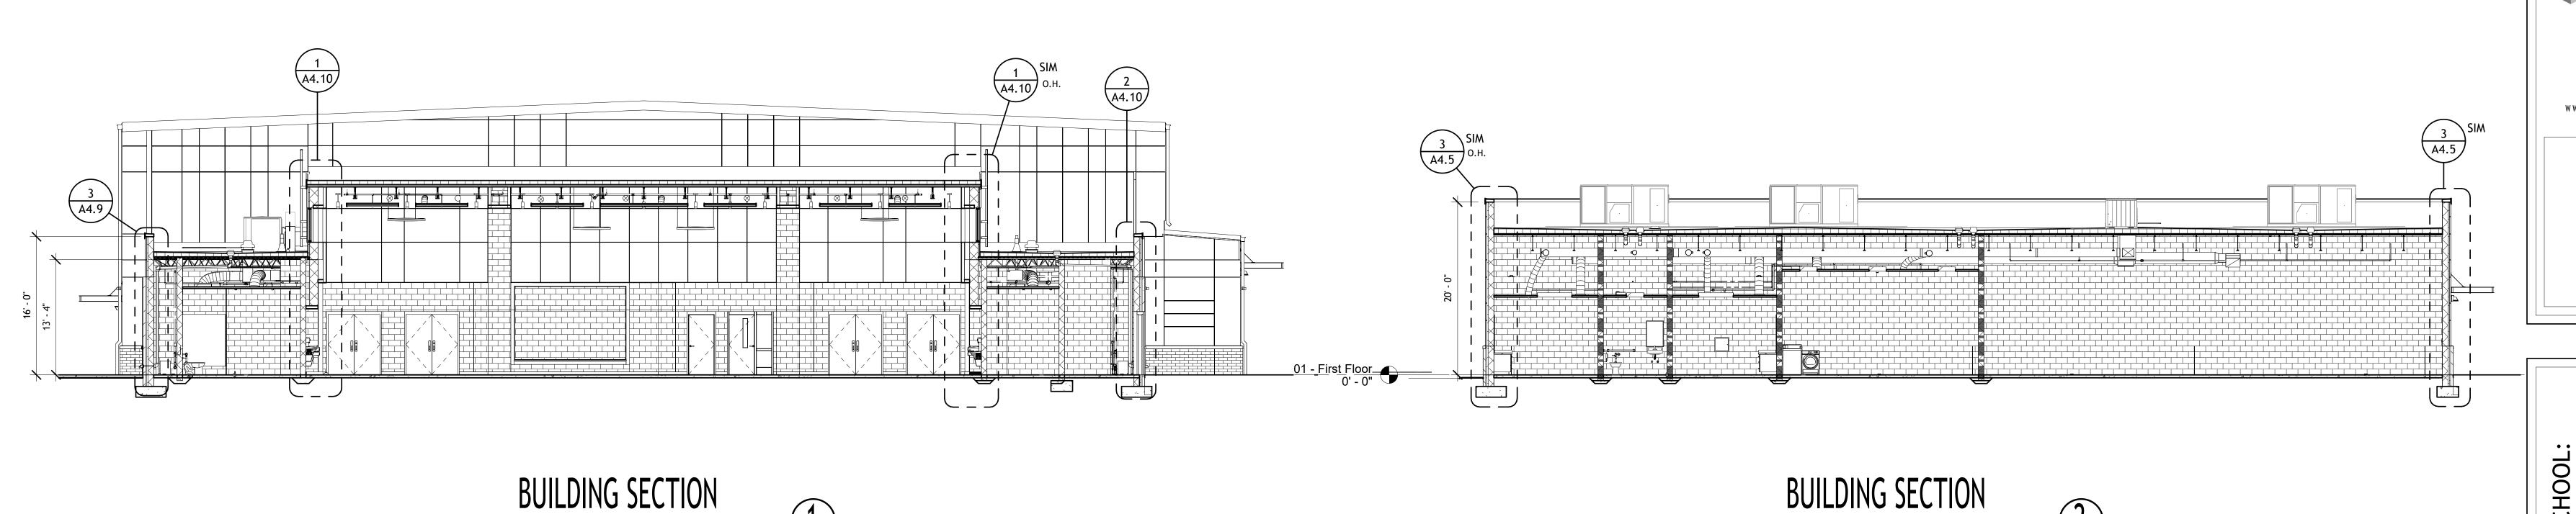

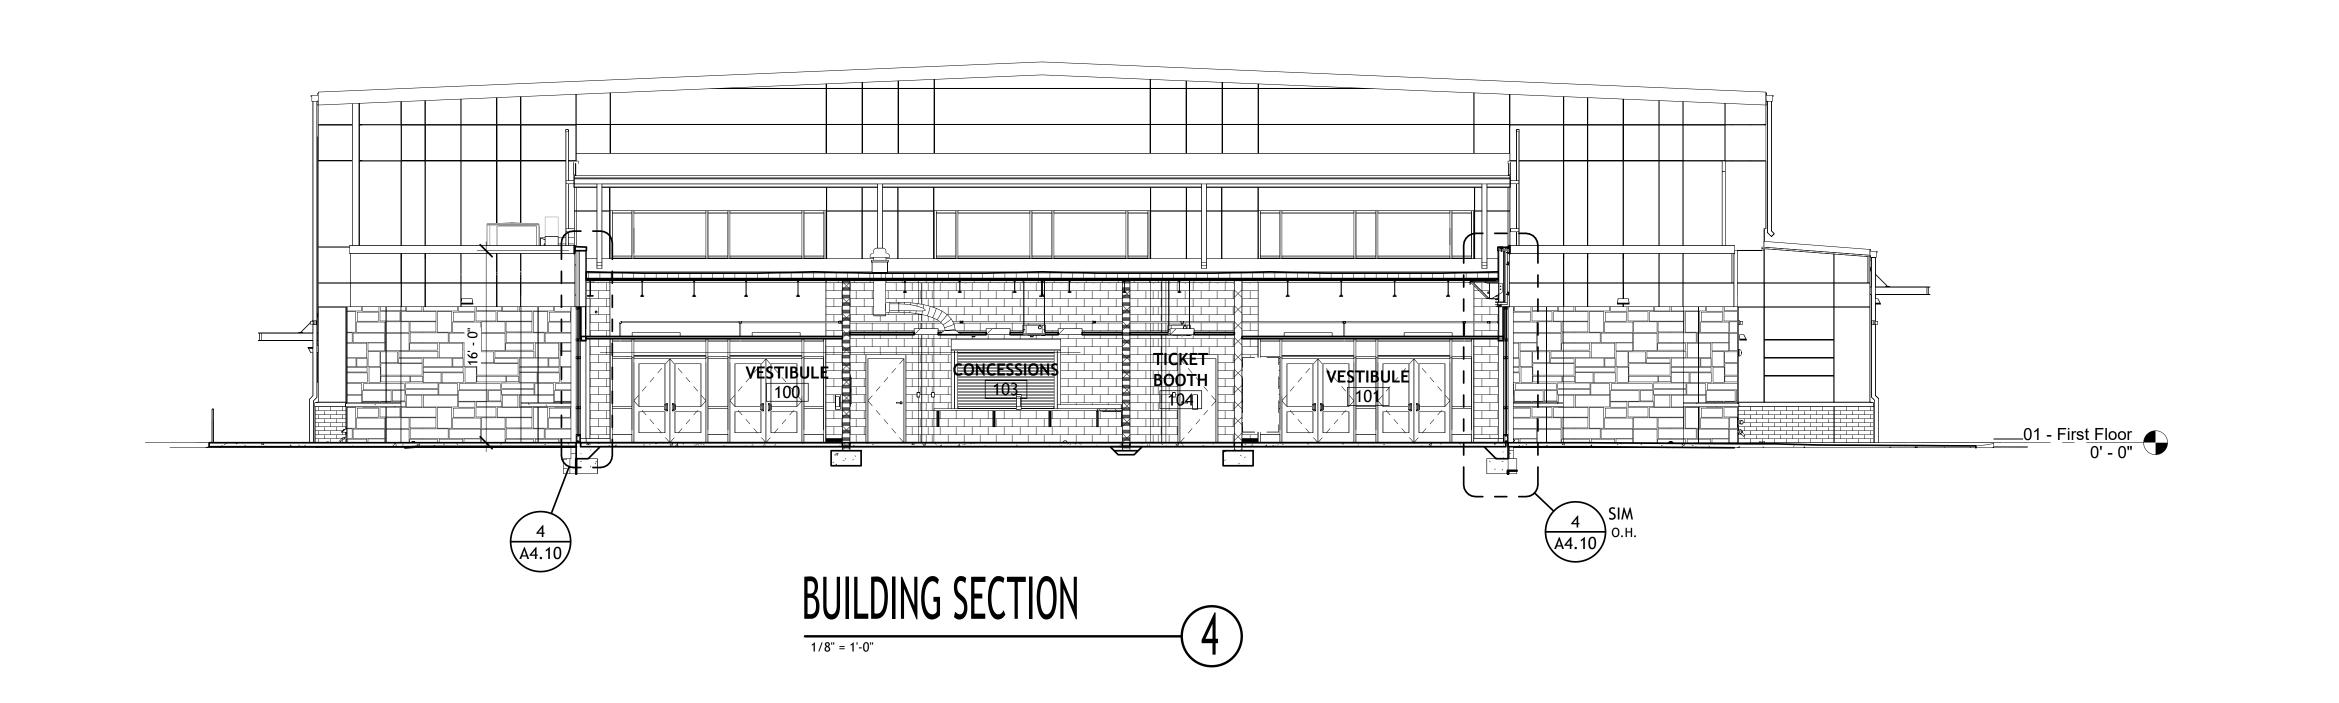

1/8" = 1'-0"

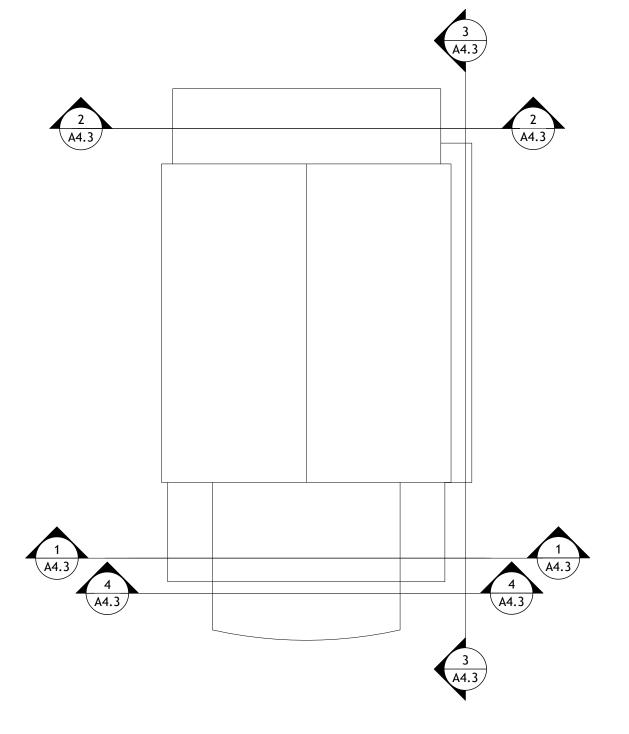

KEY PLAN

Upland Design Group

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> > LOCATION
> > SVILLE, TN

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AL CHAMERON CHAMEN 1/30/28

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ISSUE DATE

E DATE 1-30-23

SHEET TITLE

BUILDING SECTIONS

DRAWN CWD

REVIEW A4.3