



PREPARED FOR

PROJECT INFORMATION

VERIZON SITE ID:	SMC_CBRLD_MD_CTR_CRSVILE_1-SITERRA
PROJECT DESCRIPTION:	PROPOSED DECORATIVE POLE
NEAREST ADDRESS: (E911 ADDRESS PENDING)	396 S MAIN ST CROSSVILLE, TN 38555
POLE OWNER	VERIZON
LATITUDE:	N 35° 56' 32.7" (N 35.94242)
LONGITUDE:	W 85° 01' 22.7" (W -85.02297)
GROUND ELEVATION:	(AMSL) = 1869±
PRESENT OCCUPANCY TYPE:	PUBLIC ROW
JURISDICTION:	CITY OF CROSSVILLE
ROW JURISDICTION:	TDOT_DIV2
COUNTY:	CUMBERLAND
DISTURBED AREA:	25 SQ FT ±
CURRENT ZONING	N/A
PARCEL ID #:	N/A
APPLICANT:	VERIZON WIRELESS 8921 RESEARCH DRIVE CHARLOTTE, NC 28262 USHA GADE (704) 510-8718
PROJECT MANAGER:	VERIZON WIRELESS 8921 RESEARCH DRIVE CHARLOTTE, NC 28262 USHA GADE (704) 510-8718
ENGINEER:	TOWERSOURCE 1875 OLD ALABAMA ROAD, SUITE 1008 ROSWELL, GA 30076 678-990-2338

CALL PROJECT MANAGER BEFORE CONSTRUCTION STARTS

SHEET	SHEET TITLE	REV
A1	TITLE SHEET	0
EN	ELECTRICAL NOTES	0
B1	SITE PLAN	0
B2	DETAIL SITE PLAN	0
C1	POLE ELEVATION	0
C2.1	PHOTO SIMS (1)	0
C2.2	PHOTO SIMS (2)	0
C3	TRAFFIC CONTROL	0
C4	DETAILS	0
E1	ONE LINE DIAGRAM	0
E2	RFDS & PLUMBING DIAGRAM	0
E3	GROUNDING DETAILS	0
S1	RRUS SPECS	0
S2	EQUIPMENT SPECS	0
S3	EQUIPMENT SPECS	0

UTILITY INFORMATION	
POWER COMPANY:	VOLUNTEER ENERGY COOPERATIVE
CONTACT:	CUSTOMER SERVICE
PHONE:	1 (811) 833-2217
METER # NEAR SITE:	UNKNOWN
TELEPHONE COMPANY:	AT&T
CONTACT:	CUSTOMER SERVICE
PHONE:	1 (800) 288-2020
PHONE # NEAR SITE:	UNKNOWN
PEDESTAL # NEAR SITE:	UNKNOWN

CODE COMPLIANCE	
ALL WORK AND MATERIALS SHALL BE PERFORMED AND INSTALLED IN ACCORDANCE WITH THE CURRENT EDITIONS OF THE FOLLOWING CODES AS ADOPTED BY THE LOCAL GOVERNING AUTHORITIES. NOTHING IN THESE PLANS IS TO BE CONSTRUED TO PERMIT WORK NOT CONFORMING TO THE LATEST EDITIONS OF THE FOLLOWING:	
1.	2012 TENNESSEE BUILDING CODE (IBC - 2012)
2.	TN-229
3.	2017 NEC - NFPA 70
4.	2012 NESC

GENERAL NOTES:

- FOR THE PURPOSE OF CONSTRUCTION DRAWINGS, THE FOLLOWING DEFINITIONS SHALL APPLY:
GENERAL CONTRACTOR: (CONSTRUCTION) OWNER - VERIZON
- ALL SITE WORK SHALL BE COMPLETED AS INDICATED ON THE DRAWINGS AND VERIZON PROJECT SPECIFICATIONS. THE CONTRACTOR MUST HAVE CONSIDERABLE EXPERIENCE IN PERFORMANCE OF WORK SIMILAR TO THAT DESCRIBED HERIN. BY ACCEPTANCE OF THIS ASSIGNMENT, THE CONTRACTOR IS ATTESTING THAT HE DOES HAVE SUFFICIENT EXPERIENCE AND ABILITY. THAT HE IS KNOWLEDGEABLE OF THE WORK TO BE PERFORMED AND THAT HE IS PROPERLY LICENSED AND PROPERLY REGISTERED TO DO THIS WORK IN THE STATE OF TENNESSEE.
- GENERAL CONTRACTOR SHALL VISIT THE SITE AND SHALL FAMILIARIZE HIMSELF WITH ALL CONDITIONS AFFECTING THE PROPOSED WORK AND SHALL MAKE PROVISIONS. GENERAL CONTRACTOR SHALL BE RESPONSIBLE FOR FAMILIARIZING HIMSELF WITH ALL CONTRACT DOCUMENTS, FIELD CONDITIONS, DIMENSIONS, AND CONFIRMING THAT THE WORK MAY BE ACCOMPLISHED AS SHOWN PRIOR TO PROCEEDING WITH CONSTRUCTION. ANY DISCREPANCIES SHALL BE BROUGHT TO THE ATTENTION OF THE ENGINEER PRIOR TO THE COMMENCEMENT OF WORK.
- ALL MATERIALS FURNISHED AND INSTALLED SHALL BE IN STRICT ACCORDANCE WITH ALL APPLICABLE CODES, REGULATIONS, AND ORDINANCES. GENERAL CONTRACTOR SHALL ISSUE ALL APPROPRIATE NOTICES AND COMPLY WITH ALL LAWS, ORDINANCES, RULES, REGULATIONS, AND LAWFUL ORDERS OF ANY PUBLIC AUTHORITY REGARDING THE PERFORMANCE OF WORK. ALL WORK CARRIED OUT SHALL COMPLY WITH ALL APPLICABLE MUNICIPAL AND UTILITY COMPANY SPECIFICATIONS AND LOCAL JURISDICTIONAL CODES, ORDINANCES, AND APPLICABLE REGULATIONS.
- UNLESS NOTED OTHERWISE, THE WORK SHALL INCLUDE FURNISHING MATERIALS, EQUIPMENT, APPURTENANCES, AND LABOR NECESSARY TO COMPLETE ALL INSTALLATIONS AS INDICATED ON THE DRAWINGS.
- PLANS ARE NOT TO BE SCALED. THESE PLANS ARE INTENDED TO BE A DIAGRAMMATIC OUTLINE ONLY UNLESS OTHERWISE NOTED. DIMENSIONS SHOWN ARE TO FINISH SURFACES UNLESS OTHERWISE NOTED. SPACING BETWEEN EQUIPMENT IS THE MINIMUM REQUIRED CLEARANCE. THEREFORE, IT IS CRITICAL TO FIELD VERIFY DIMENSIONS. SHOULD THERE BE ANY QUESTIONS REGARDING THE CONTRACT DOCUMENTS, THE CONTRACTOR SHALL BE RESPONSIBLE FOR OBTAINING A CLARIFICATION FROM THE ENGINEER PRIOR TO PROCEEDING WITH THE WORK. DETAILS ARE INTENDED TO SHOW DESIGN INTENT. MODIFICATIONS MAY BE REQUIRED TO SUIT JOB DIMENSIONS OR CONDITIONS AND SUCH MODIFICATIONS SHALL BE INCLUDED AS PART OF WORK AND PREPARED BY THE ENGINEER PRIOR TO PROCEEDING WITH WORK.
- THE CONTRACTOR SHALL INSTALL ALL EQUIPMENT AND MATERIALS IN ACCORDANCE WITH MANUFACTURER'S RECOMMENDATIONS UNLESS SPECIFICALLY STATED OTHERWISE.
- IF THE SPECIFIED EQUIPMENT CANNOT BE INSTALLED AS SHOWN ON THESE DRAWINGS, THE CONTRACTOR SHALL PROPOSE AN ALTERNATIVE INSTALLATION SPACE FOR APPROVAL BY THE ENGINEER PRIOR TO PROCEEDING.
- GENERAL CONTRACTOR SHALL BE RESPONSIBLE FOR THE SAFETY OF WORK AREA, ADJACENT AREAS AND BUILDING OCCUPANTS THAT ARE LIKELY TO BE AFFECTED BY THE WORK UNDER THIS CONTRACT. WORK SHALL CONFIRM TO ALL OSHA REQUIREMENTS AND THE LOCAL JURISDICTION.
- ERECTION SHALL BE DONE IN A WORKMANLIKE MANNER BY COMPETENT EXPERIENCED WORKMAN IN ACCORDANCE WITH APPLICABLE CODES AND THE BEST ACCEPTED PRACTICE. ALL MEMBERS SHALL BE LAID PLUMB AND TRUE AS INDICATED ON THE DRAWINGS.
- THE CONTRACTOR SHALL PROTECT EXISTING IMPROVEMENTS, PAVEMENTS, CURBS, LANDSCAPING AND STRUCTURES. ANY DAMAGED PART SHALL BE REPAIRED AT CONTRACTOR'S EXPENSE TO THE SATISFACTION OF THE OWNER.
- THE CONTRACTOR SHALL CONTACT UTILITY LOCATING SERVICES MIN 48 HOURS PRIOR TO THE START OF CONSTRUCTION.
- GENERAL CONTRACTOR SHALL COORDINATE AND MAINTAIN ACCESS FOR ALL TRADES AND CONTRACTORS TO THE SITE AND/OR BUILDING.
- THE GENERAL CONTRACTOR SHALL BE RESPONSIBLE FOR SECURITY OF THE SITE FOR THE DURATION OF CONSTRUCTION UNTIL JOB COMPLETION.
- THE GENERAL CONTRACTOR SHALL MAINTAIN IN GOOD CONDITION ONE COMPLETE SET OF PLANS WITH ALL REVISIONS, ADDENDA, AND CHANGE ORDERS ON THE PREMISES AT ALL TIMES.

- THE GENERAL CONTRACTOR SHALL PROVIDE PORTABLE FIRE EXTINGUISHERS WITH A RATING OF NOT LESS THAN 2-A OR 2-A:10-B:C AND SHALL BE WITHIN 25 FEET OF TRAVEL DISTANCE TO ALL PORTIONS OF WHERE THE WORK IS BEING COMPLETED DURING CONSTRUCTION.
- ALL EXISTING ACTIVE SEWER, WATER, GAS, ELECTRIC, AND OTHER UTILITIES SHALL BE PROTECTED AND FREE FROM OBSTRUCTION AT ALL TIMES, AND WHERE REQUIRED FOR THE PROPER EXECUTION OF THE WORK, SHALL BE RELOCATED AS DIRECTED BY THE GOVERNING UTILITY COMPANY ENGINEER.
- CONTRACTOR SHALL MINIMIZE DISTURBANCE TO THE EXISTING SITE DURING CONSTRUCTION. EROSION CONTROL MEASURES, IF REQUIRED DURING CONSTRUCTION, SHALL BE IN CONFORMANCE WITH THE FEDERAL AND LOCAL JURISDICTION FOR EROSION AND SEDIMENT CONTROL.
- THE SUBGRADE SHALL BE BROUGHT TO A SMOOTH UNIFORM GRADE AND COMPACTED TO 95 PERCENT STANDARD PROCTOR DENSITY UNDER PAVEMENT AND STRUCTURES AND 80 PERCENT STANDARD PROCTOR DENSITY IN OPEN SPACE. ALL TRENCHES IN PUBLIC RIGHT OF WAY SHALL BE BACKFILLED WITH FLOWABLE FILL OR OTHER MATERIAL PRE-APPROVED BY THE LOCAL JURISDICTION.
- ALL NECESSARY RUBBISH, STUMPS, DEBRIS, STICKS, STONES, AND OTHER REFUSE SHALL BE REMOVED FROM THE SITE AND DISPOSED OF IN A LAWFUL MANNER.
- ALL BROCHURES, OPERATING AND MAINTENANCE MANUALS, CATALOGS, SHOP DRAWINGS, AND OTHER DOCUMENTS SHALL BE TURNED OVER TO THE GENERAL CONTRACTOR AT COMPLETION OF CONSTRUCTION AND PRIOR TO PAYMENT.
- CONTRACTOR SHALL SUBMIT A COMPLETE SET OF AS-BUILT REDLINES TO THE GENERAL CONTRACTOR UPON COMPLETION OF PROJECT AND PRIOR TO FINAL PAYMENT.
- ALL MATERIAL SHALL BE FURNISHED AND WORK SHALL BE PERFORMED IN ACCORDANCE WITH THE LATEST REVISION VERIZON MOBILITY GROUNDING STANDARD "TECHNICAL SPECIFICATION FOR CONSTRUCTION OF GSM/GPRS WIRELESS SITES" AND "TECHNICAL SPECIFICATION FOR FACILITY GROUNDING". IN CASE OF A CONFLICT BETWEEN THE CONSTRUCTION SPECIFICATION AND THE DRAWINGS, THE DRAWINGS SHALL GOVERN.
- CONTRACTORS SHALL BE RESPONSIBLE FOR OBTAINING ALL PERMITS AND INSPECTIONS REQUIRED FOR CONSTRUCTION. IF CONTRACTOR CANNOT OBTAIN A PERMIT, THEY MUST NOTIFY THE GENERAL CONTRACTOR IMMEDIATELY.
- CONTRACTOR SHALL REMOVE ALL TRASH AND DEBRIS FROM THE SITE ON A DAILY BASIS. ALL WASTE MATERIALS TO BE REMOVED FROM SITE PRIOR TO SUBSTANTIAL COMPLETION AND PRIOR TO FINAL ACCEPTANCE.
- THE CONTRACTOR SHALL GUARANTEE THE WORK PERFORMED ON THE PROJECT BY THE CONTRACTOR AND ANY OR ALL OF THE SUBCONTRACTORS WHO PERFORMED WORK FOR THE CONTRACTOR ON THIS PROJECT. THE GUARANTEE SHALL BE FOR ONE FULL YEAR FOLLOWING ISSUANCE OF THE FINAL PAYMENT OF RETAINAGE. ALL MATERIALS AND WORKMANSHIP SHALL BE WARRANTED FOR ONE YEAR FROM ACCEPTANCE DATE.
- THE CONTRACTOR AND ITS SUBCONTRACTORS SHALL CARRY LIABILITY INSURANCE IN THE AMOUNTS AND FORM IN ACCORDANCE WITH LESSEE SPECIFICATIONS. CERTIFICATES DEMONSTRATING PROOF OF COVERAGE SHALL BE PROVIDED TO LESSEE PRIOR TO THE START OF THE WORK ON THE PROJECT.
- THE CONTRACTOR SHALL REWORK (DRY, SCARIFY, ETC) ALL MATERIAL NOT SUITABLE FOR SUBGRADE IN ITS PRESENT STATE. AFTER REWORKING, IF THE MATERIAL REMAINS UNSUITABLE, THE CONTRACTOR SHALL UNDERCUT THIS MATERIAL AND REPLACE WITH APPROVED MATERIAL. ALL SUBGRADES SHALL BE PROOFROLLED WITH A FULLY LOADED TANDEM AXLE DUMP TRUCK PRIOR TO PAVING. ANY SOFT MATERIAL SHALL BE REWORKED AND REPLACED.
- ANY BUILDING ON THIS SITE ARE INTENDED TO SHELTER EQUIPMENT WHICH WILL ONLY BE PERIODICALLY MAINTAINED AND ARE NOT INTENDED FOR HUMAN OCCUPANCY.
- TEMPORARY FACILITIES FOR PROTECTION OF TOOLS AND EQUIPMENT SHALL CONFORM TO LOCAL REGULATIONS AND SHALL BE THE CONTRACTORS RESPONSIBILITY.

DRIVING DIRECTIONS:


FROM VERIZON WIRELESS HEADQUARTERS IN CHARLOTTE:

TURN RIGHT ONTO RESEARCH DR	0.4 MI	US-74 W TURNS SLIGHTLY RIGHT AND BECOMES I-26 W/US-74 W	34.4 MI	CONTINUE ONTO TN-392 N/MILLER AVE	2.5 MI
TURN LEFT ONTO W.W.T. HARRIS BLVD	0.2 MI			TURN RIGHT ONTO S MAIN ST	0.8 MI
TURN RIGHT ONTO THE I-85 S RAMP	0.3 MI	KEEP LEFT AT THE FORK TO CONTINUE ON US-74 W	0.8 MI	SITE WILL BE ON THE LEFT	
MERGE ONTO I-85 S	33.9 MI	MERGE ONTO I-40 W	129 MI		
TAKE EXIT 10B TO MERGE ONTO US-74 W KINGS MOUNTAIN/SHELBY	0.6 MI	KEEP RIGHT AT THE FORK TO STAY ON I-40 W, FOLLOW SIGNS FOR NASHVILLE	45.8 MI		
MERGE ONTO US-74 W	22.3 MI	TAKE EXIT 322 FOR TN-101/PEAVINE RD TOWARD CROSSVILLE	0.2 MI		
CONTINUE ONTO US-74 W	33 MI	TURN LEFT ONTO TN-101 S/ PEAVINE RD	0.4 MI		

GENERAL LOCATION MAP



SITE LOCATION PHOTO

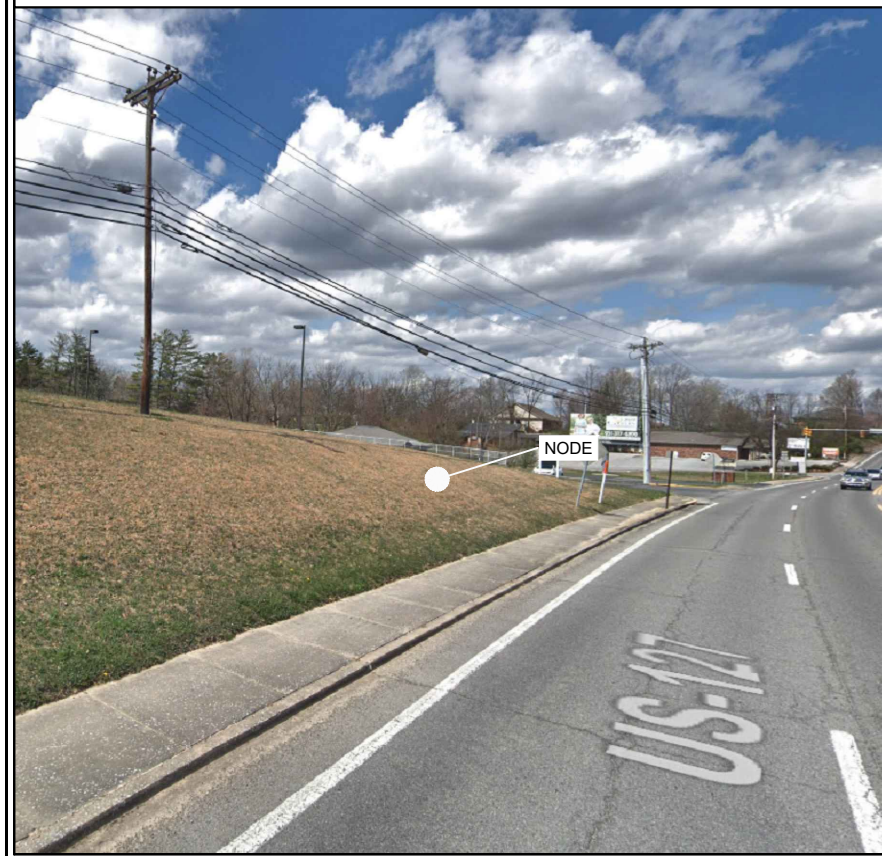

PREPARED FOR:

1000 WILLIAMS BLVD
KENNER, LA 70062



A&E FIRM:

1875 OLD ALABAMA ROAD, SUITE 1008
ROSWELL, GA 30076
TEL: 678-990-2338 FAX: 678-990-2342

REGISTERED PROFESSIONAL ENGINEER SEAL:
THE INFORMATION CONTAINED IN THIS SET OF DOCUMENTS IS PROPRIETARY BY NATURE. ANY USE OR DISCLOSURE OTHER THAN THAT WHICH RELATES TO THE CLIENT IS STRICTLY PROHIBITED.

REVISION		
REV	DATE	DESCRIPTION
0	10/23/2019	ISSUED FOR CONSTRUCTION

DRAWN BY: BA | CHECKED BY: JKP

CAUTION
FOREIGN UTILITY LOCATIONS ARE APPROXIMATE. CONTACT THE LOCAL ONE CALL AGENCY 48 HOURS PRIOR TO CONSTRUCTION FOR EXACT UTILITY LOCATION AT:

CONSTRUCTION SHALL NOTIFY THE JURISDICTION'S, DEPARTMENT OF PUBLIC WORKS AND ENGINEERING, OFFICE OF THE CITY ENGINEER, 48 HOURS BEFORE STARTING WORK IN THIS PROJECT.

PROJECT INFORMATION:
VERIZON SITE ID
SMC_CBRLD_MD_CTR_CRSVILE_1-SITERRA
NEAREST ADDRESS
396 S MAIN ST
CROSSVILLE, TN 38555
(CUMBERLAND COUNTY)

SHEET TITLE: TITLE SHEET	
SHEET NO. A1	REVISION: 0



PROPERTY INFORMATION				
NO.	PARCEL #	N/F PROPERTY OWNER	DEED BOOK	PAGE
1	113F E 002.00	CUMBERLAND COUNTY	423	209
2	113F E 001.02	THOMAS B RIDLEY PROPERTIES GP	1517	385
3				
4				

- NOTES:**
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 - CONTRACTOR SHALL MAINTAIN UNINTERRUPTED ACCESS TO ALL DRIVEWAYS, SIDE STREETS AND WALKWAYS AT ALL TIMES UNLESS OTHERWISE PERMITTED.
 - CONTRACTOR SHALL PREPARE A MAINTENANCE OF TRAFFIC (M.O.T.) PLAN FOR PEDESTRIAN TRAFFIC AND WORK WITHIN THE RIGHT-OF-WAY, INCLUDING VEHICLE PARKING AND EQUIPMENT STAGING.
 - CONTRACTOR SHALL RESTORE ANY DISTURBED AREAS TO ORIGINAL CONDITION OR BETTER.
 - POWER DELIVERY BY VOLUNTEER ENERGY COOPERATIVE AT THEIR RECOMMENDATION, PERMITTED SEPARATELY.
 - FIBER DELIVERY PROVIDED BY AT&T, PERMITTED SEPARATELY.

- UTILITY NOTES:**
- CONTRACTOR TO CONTACT VOLUNTEER ENERGY COOPERATIVE TO INITIATE POWER ROUTE INSTALLATION.
NAME: CUSTOMER SERVICE
PHONE: 1 (931) 839-2217
EMAIL: UNKNOWN
 - POWER COMPANY WILL PROVIDE 100A --- SERVICE FROM EXISTING --- TO VZW PROPOSED DECORATIVE POLE.
 - VZW CONTRACTOR WILL INSTALL A TOTAL OF ±38' OF 3" SCH40 CONDUIT ON PROPOSED POLE AT NODE LOCATION.
 - VZW CONTRACTOR WILL PROVIDE THE METER BASE. POWER COMPANY WILL PROVIDE METER.

NODE: SMC_CBRLD_MD_CTR_CRSVILLE_1-SITERRA
 PROJECT DESCRIPTION: PROPOSED DECORATIVE POLE
 LAT: N 35° 56' 32.7" (N 35.94242)
 LONG: W 85° 01' 22.7" (W -85.02297)

STREET LIGHT	○ STLT	FIBER MARKER	○ FM
POLE W/ LIGHT	⊗ STLT	PARKING METER	○ PM
UTILITY POLE	⊠ STLT	MANHOLE	⊠ MH
LIGHT POLE	⊗ UP W/L	TELCO BOX	□ TCO
FIRE HYDRANT	⊗ UP	GAS VALVE	○ GV
TRAFFIC POLE	⊗ LP	TRANSFORMER	□ TR
HANDHOLE	⊗ FH	WATER VALVE	○ WV
WATER METER	⊗ TP	SEWER	⊗ PED
UTILITY MARKER	□ HH	PEDESTAL	⊗ PED
CULVERT	○ WM	INLET	□
TREE	○ UM	CABINET	□
	⊗	DRAIN CRATE	⊠
	⊗	CROSSWALK	⊠
	⊗	TRAFFIC SIGNAL	⊠

OVERHEAD POWER	_____	OHP
UNDERGROUND POWER	_____	UGP
UNDERGROUND FIBER	_____	UGF
UNDERGROUND GAS	_____	UGG
WATER LINE	_____	WTR
STORM SEWER	_____	STS
SANITARY SEWER	_____	SS
RIGHT OF WAY	_____	ROW
EDGE OF PAVEMENT	_____	EOP
FENCE	_____	X
CENTER LINE	_____	
PROPERTY LINE	_____	
EXISTING BUILDING	_____	
LANE LINES	_____	
DRIVEWAY/SIDEWALK	_____	
BACK OF CURB	_____	BOC
OVERHEAD CATV	_____	CATV
	_____	CATV

PREPARED FOR:
verizon
 1000 WILLIAMS BLVD
 KENNER, LA 70062

A&E FIRM:
towersource
 1875 OLD ALABAMA ROAD, SUITE 1008
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DRAWN BY: BA CHECKED BY: JKP

CAUTION
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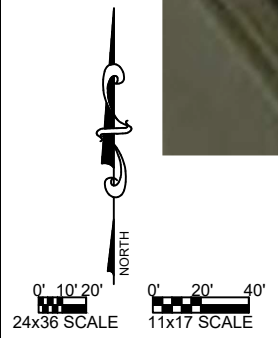


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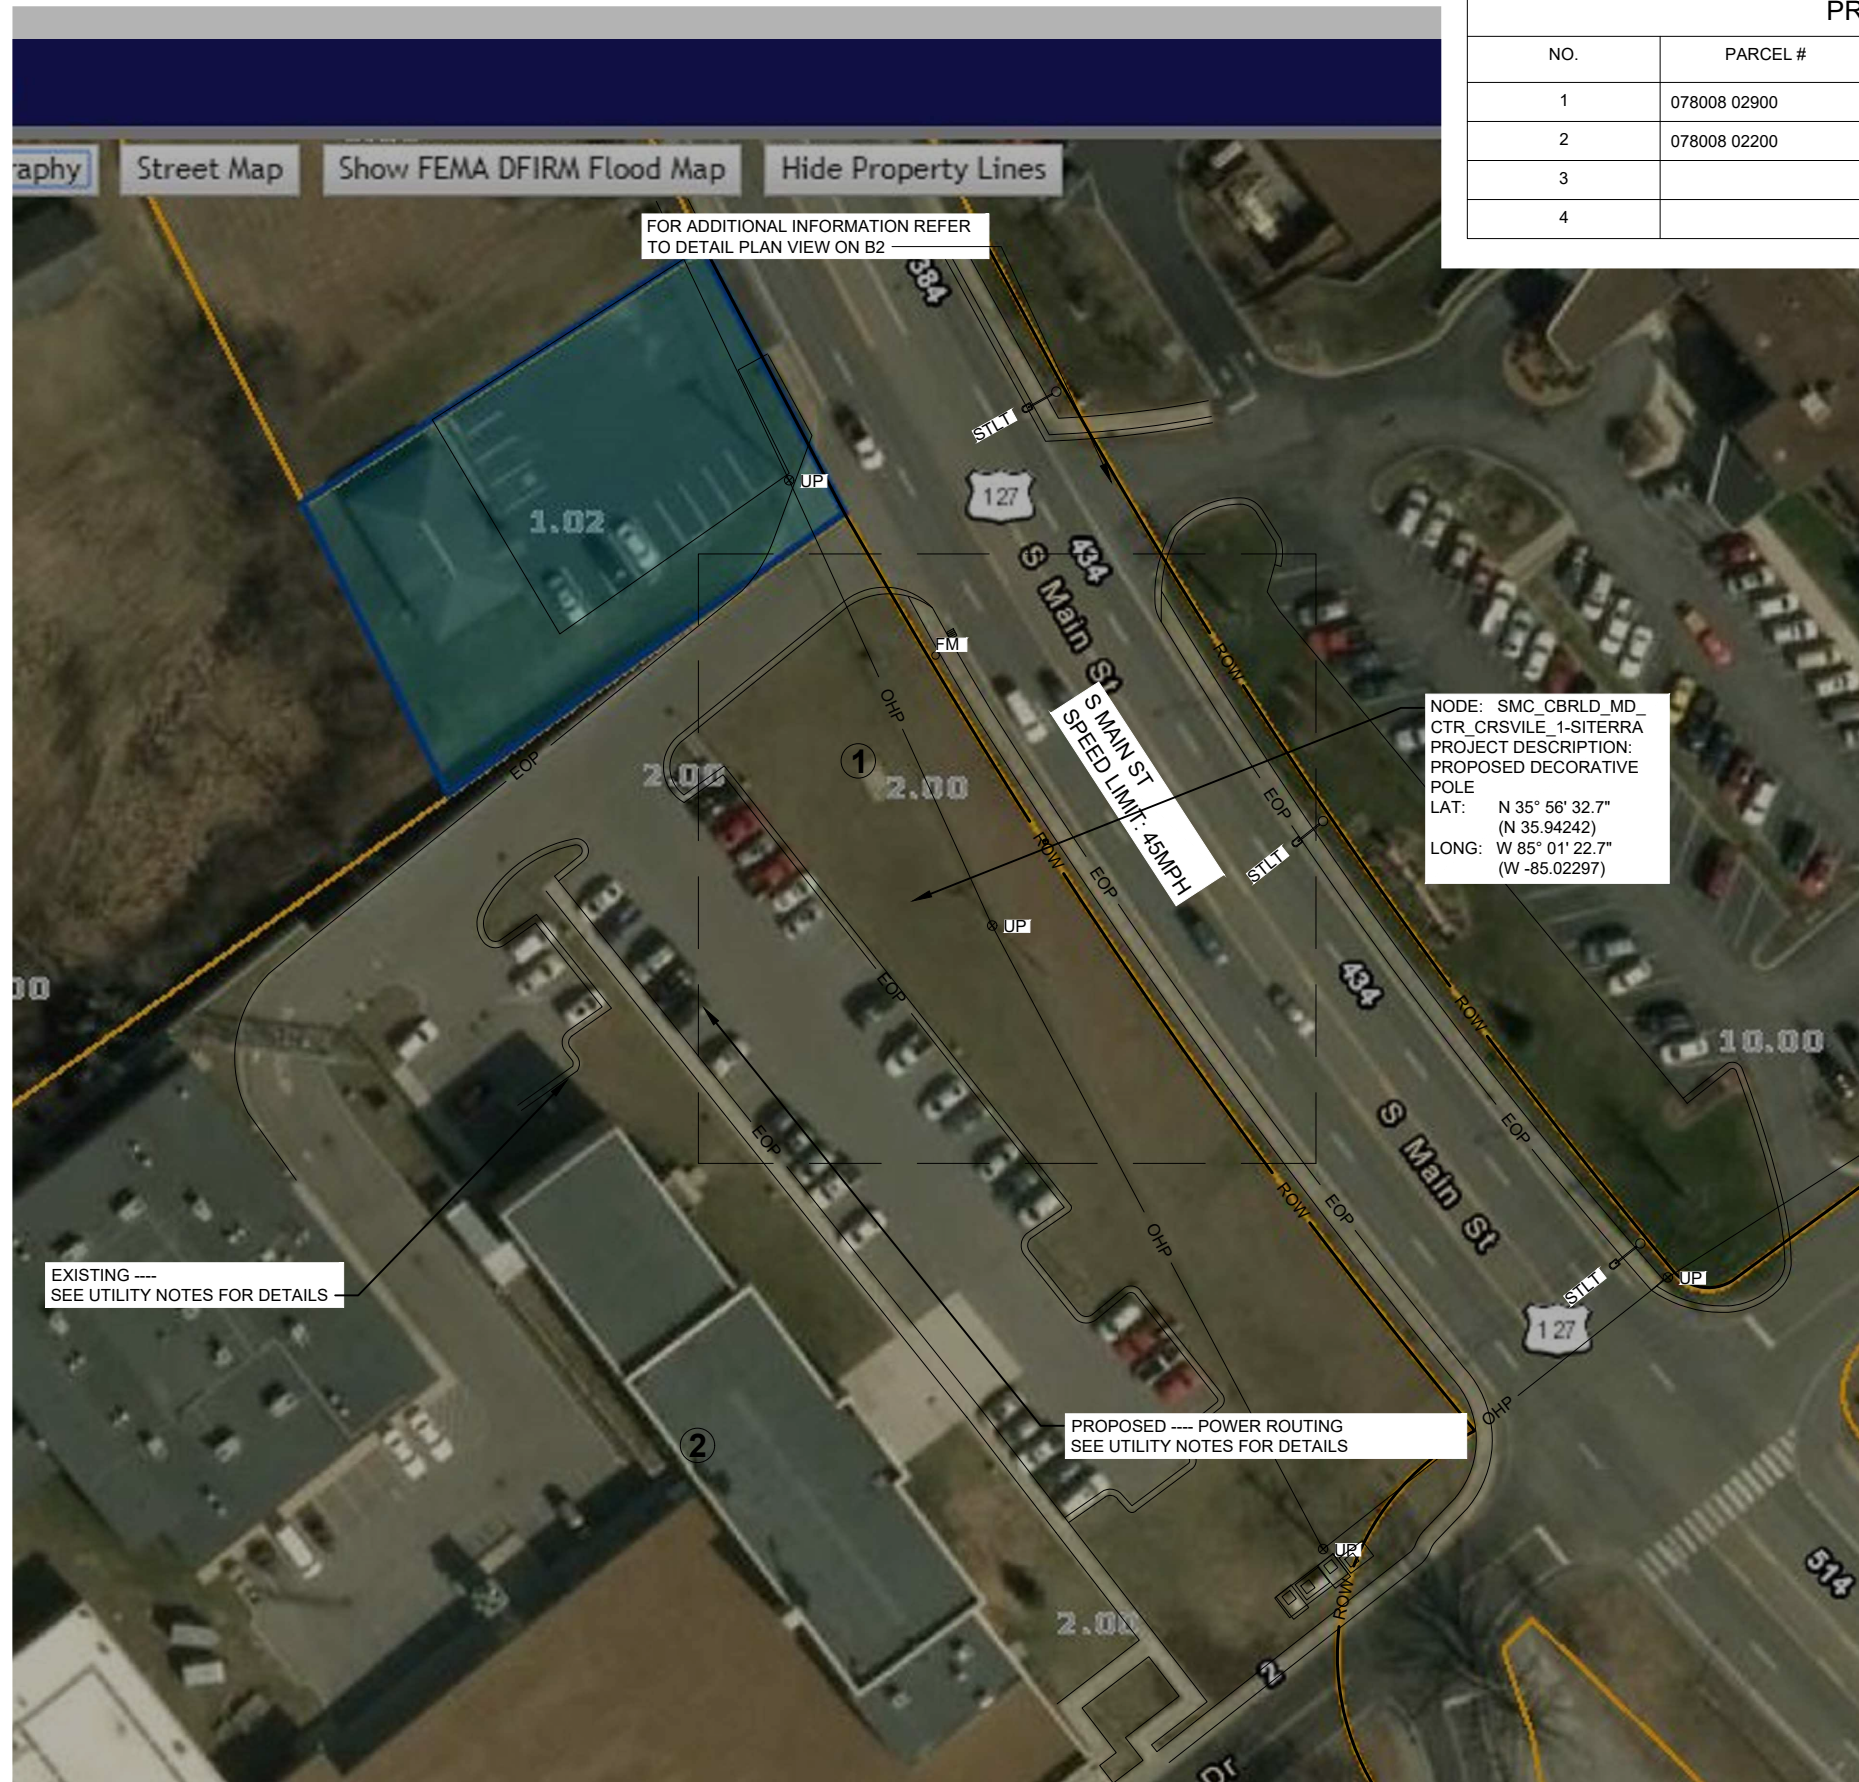
PROJECT INFORMATION:
VERIZON SITE ID
 SMC_CBRLD_MD_CTR_CRSVILLE_1-SITERRA
NEAREST ADDRESS
 396 S MAIN ST
 CROSSVILLE, TN 38555
 (CUMBERLAND COUNTY)

SHEET TITLE:
SITE PLAN

SHEET NO. **B1** REVISION: **0**



1 SITE PLAN
B1 11x17 SCALE: 1" = 40'
 24x36 SCALE: 1" = 20'



PROPERTY INFORMATION				
NO.	PARCEL #	N/F PROPERTY OWNER	DEED BOOK	PAGE
1	078008 02900	MOUNTAIN COMMERCE BANK	N/A	N/A
2	078008 02200	BASS PRO STATION LLC	1945	782
3				
4				

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 2. CONTRACTOR SHALL MAINTAIN UNINTERRUPTED ACCESS TO ALL DRIVEWAYS, SIDE STREETS AND WALKWAYS AT ALL TIMES UNLESS OTHERWISE PERMITTED.
 3. CONTRACTOR SHALL PREPARE A MAINTENANCE OF TRAFFIC (M.O.T.) PLAN FOR PEDESTRIAN TRAFFIC AND WORK WITHIN THE RIGHT-OF-WAY, INCLUDING VEHICLE PARKING AND EQUIPMENT STAGING.
 4. CONTRACTOR SHALL RESTORE ANY DISTURBED AREAS TO ORIGINAL CONDITION OR BETTER.
 5. POWER DELIVERY BY SEVIER COUNTY ELECTRIC SYSTEM AT THEIR RECOMMENDATION, PERMITTED SEPARATELY.
 6. FIBER DELIVERY PROVIDED BY AT&T, PERMITTED SEPARATELY.

- UTILITY NOTES:**
1. CONTRACTOR TO CONTACT SEVIER COUNTY ELECTRIC TO INITIATE POWER ROUTE INSTALLATION.
NAME: CUSTOMER SERVICE
PHONE: 1 (865) 543-2887
EMAIL: TBD
 2. POWER COMPANY WILL PROVIDE 100A ---- SERVICE FROM EXISTING ---- TO VZW PROPOSED DECORATIVE POLE.
 4. VZW CONTRACTOR WILL INSTALL A TOTAL OF ±38' OF 3" SCH40 CONDUIT ON PROPOSED POLE AT NODE LOCATION.
 5. VZW CONTRACTOR WILL PROVIDE THE METER BASE. POWER COMPANY WILL PROVIDE METER.

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CULVERT	— X —	INLET	□
TREE	☼	CABINET	□
		DRAIN CRATE	■
		CROSSWALK TRAFFIC SIGNAL	⊗

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EXISTING BUILDING	_____
LANE LINES	_____
DRIVEWAY/SIDEWALK	_____
BACK OF CURB	_____ BOC
OVERHEAD CATV	_____ CATV

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
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NEAREST ADDRESS
 396 S MAIN ST
 CROSSVILLE, TN 38555
 (CUMBERLAND COUNTY)

SHEET TITLE:
SITE PLAN

SHEET NO. **B1** REVISION: **0**

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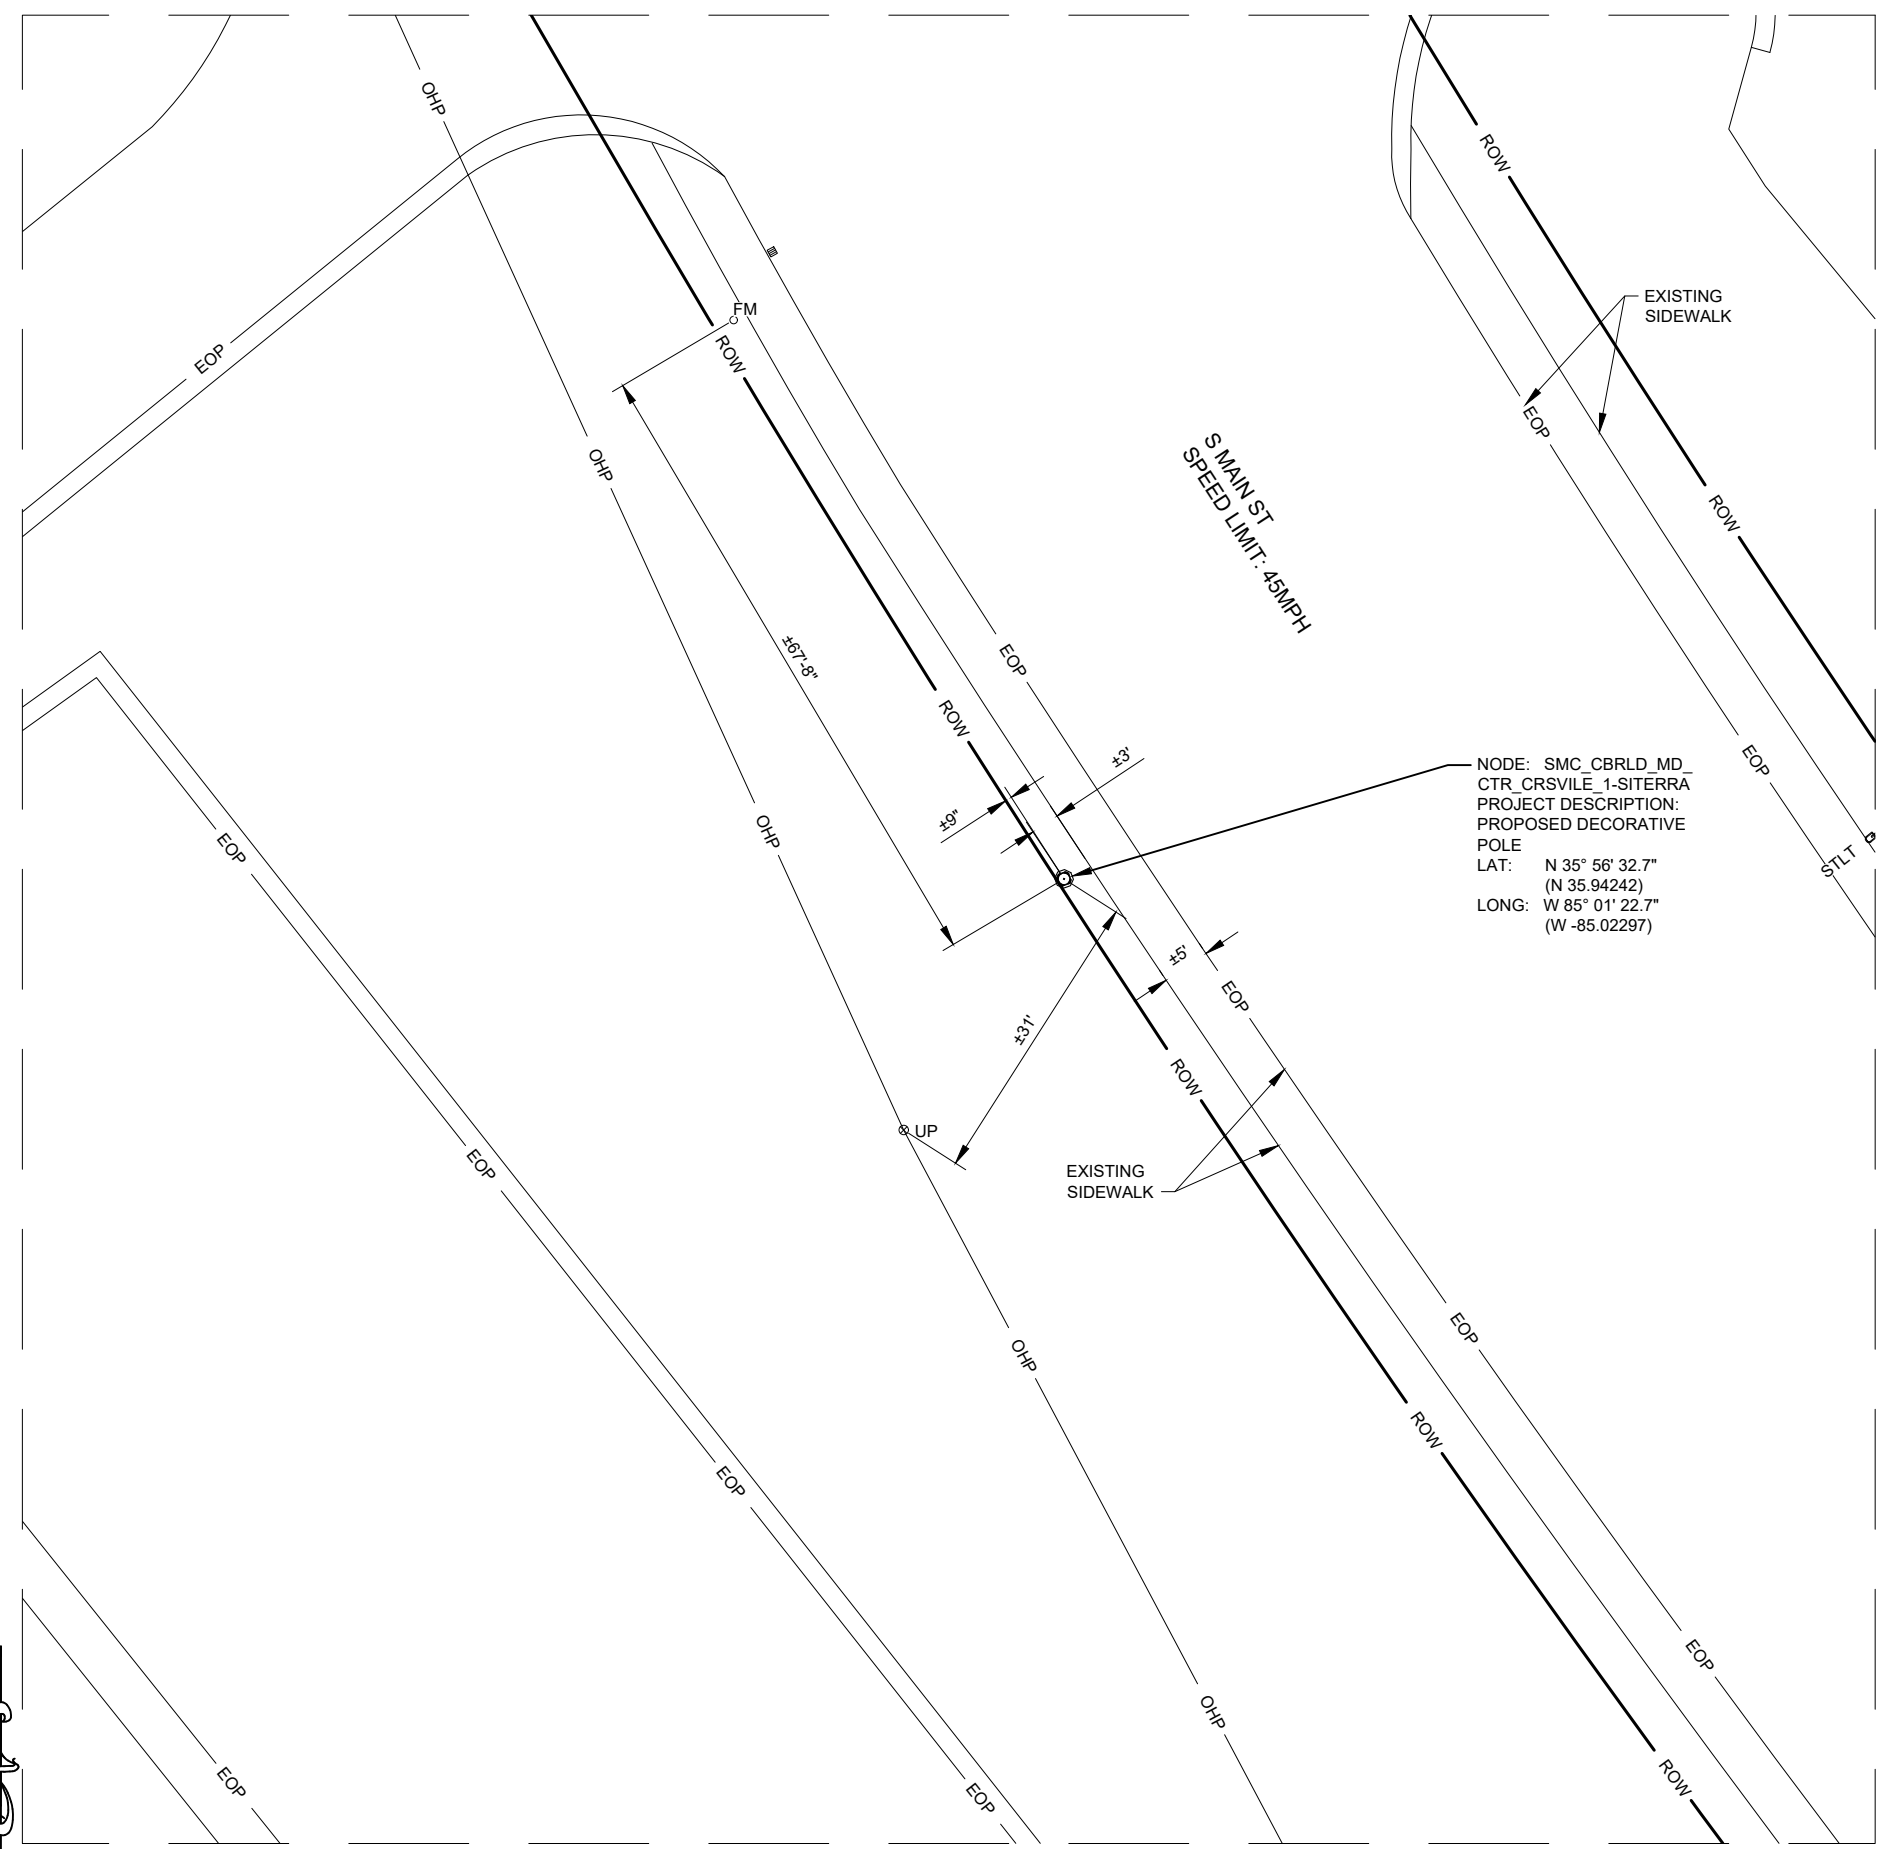
SHEET NO. **B2** REVISION: **0**

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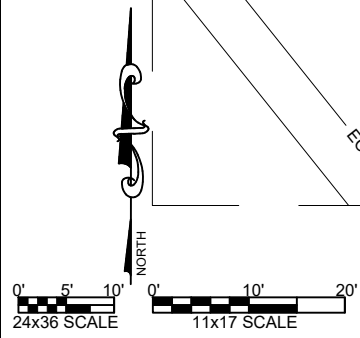
- UTILITY NOTES:**
- CONTRACTOR TO CONTACT VOLUNTEER ENERGY COOPERATIVE TO INITIATE POWER ROUTE INSTALLATION.
 NAME: CUSTOMER SERVICE
 PHONE: 1 (931) 839-2217
 EMAIL: UNKNOWN
 - POWER COMPANY WILL PROVIDE 100A ---- SERVICE FROM EXISTING ---- TO VZW PROPOSED DECORATIVE POLE.
 - VZW CONTRACTOR WILL INSTALL A TOTAL OF ±38' OF 3" SCH40 CONDUIT ON PROPOSED POLE AT NODE LOCATION.
 - VZW CONTRACTOR WILL PROVIDE THE METER BASE. POWER COMPANY WILL PROVIDE METER.

STREET LIGHT	○ STLT	FIBER MARKER	○ FM
POLE W/ LIGHT	⊙ STLT	PARKING METER	○ PM
UTILITY POLE	⊠ STLT	MANHOLE	⊠ MH
LIGHT POLE	⊙ UP W/ L	TELCO BOX	□ TCO
FIRE HYDRANT	⊙ UP	GAS VALVE	○ GV
TRAFFIC POLE	⊙ LP	TRANSFORMER	□ TR
HANDHOLE	⊙ FH	WATER VALVE	○ WV
WATER METER	⊙ TP	SEWER	⊙
UTILITY MARKER	□ HH	PEDESTAL	⊠ PED
CULVERT	○ WM	INLET	⊠
TREE	○ UM	CABINET	⊠
	⊠	DRAIN CRATE	⊠
	⊠	CROSSWALK	⊠
	⊠	TRAFFIC SIGNAL	⊠

OVERHEAD POWER	_____	OHP
UNDERGROUND POWER	_____	UGP
UNDERGROUND FIBER	_____	UGF
UNDERGROUND GAS	_____	UGG
WATER LINE	_____	WTR
STORM SEWER	_____	STS
SANITARY SEWER	_____	SS
RIGHT OF WAY	_____	ROW
EDGE OF PAVEMENT	_____	EOP
FENCE	_____	X
CENTER LINE	_____	
PROPERTY LINE	_____	
EXISTING BUILDING	_____	
LANE LINES	_____	
DRIVEWAY/SIDEWALK	_____	
BACK OF CURB	_____	BOC
OVERHEAD CATV	_____	CATV
	_____	CATV



1 DETAIL SITE PLAN
B2 11x17 SCALE: 1" = 20'
 24x36 SCALE: 1" = 10'




DESIGN NOTES

1. TOWERSOURCE HAS NOT PERFORMED A STRUCTURAL ANALYSIS OF THIS POLE. POLE OWNER TO PROVIDE.
2. FIBER TRANSPORT DELIVERY CABLES WILL BE BURIED TO POLE.
3. POWER TRANSPORT DELIVERY CABLES WILL BE BURIED TO POLE.
4. CONTRACTOR WILL COORDINATE POWER AND FIBER SERVICE REQUIREMENTS AND INSTALLATIONS WITH UTILITY COMPANIES.
5. PRIOR TO CONSTRUCTION, CONTRACTOR TO COORDINATE POLE DESIGN WITH FINAL RF DESIGN COMPONENTS.
6. CONFIRM METER TYPE WITH POWER COMPANY.
7. FUTURE CARRIES TO BE ACCOMMODATED AND ABLE TO COLLOCATE ON THIS POLE.
8. PROPOSED LAA & CBRS RADIOS TO BE POLE-MOUNTED NEAR ANTENNA TOP. CONTRACTOR TO MOUNT PER MANUFACTURER'S SPECIFICATIONS.

INSTALLATION NOTES

9. ALL INSTALLATIONS SHALL COMPLY WITH THE CURRENT PUBLISHED ISSUES OF THE NATIONAL ELECTRIC SAFETY CODE (NESC), AND POLE ATTACHMENT STANDARDS FOR POLE OWNER.
10. ANYONE WORKING ABOVE THE LOWEST PLANE OF ANY ENERGIZED AND UNSHIELDED CONDUCTOR SHALL BE A QUALIFIED ELECTRIC SUPPLY LINE WORK. SEE NESC RULE 432 FOR DETAILS.

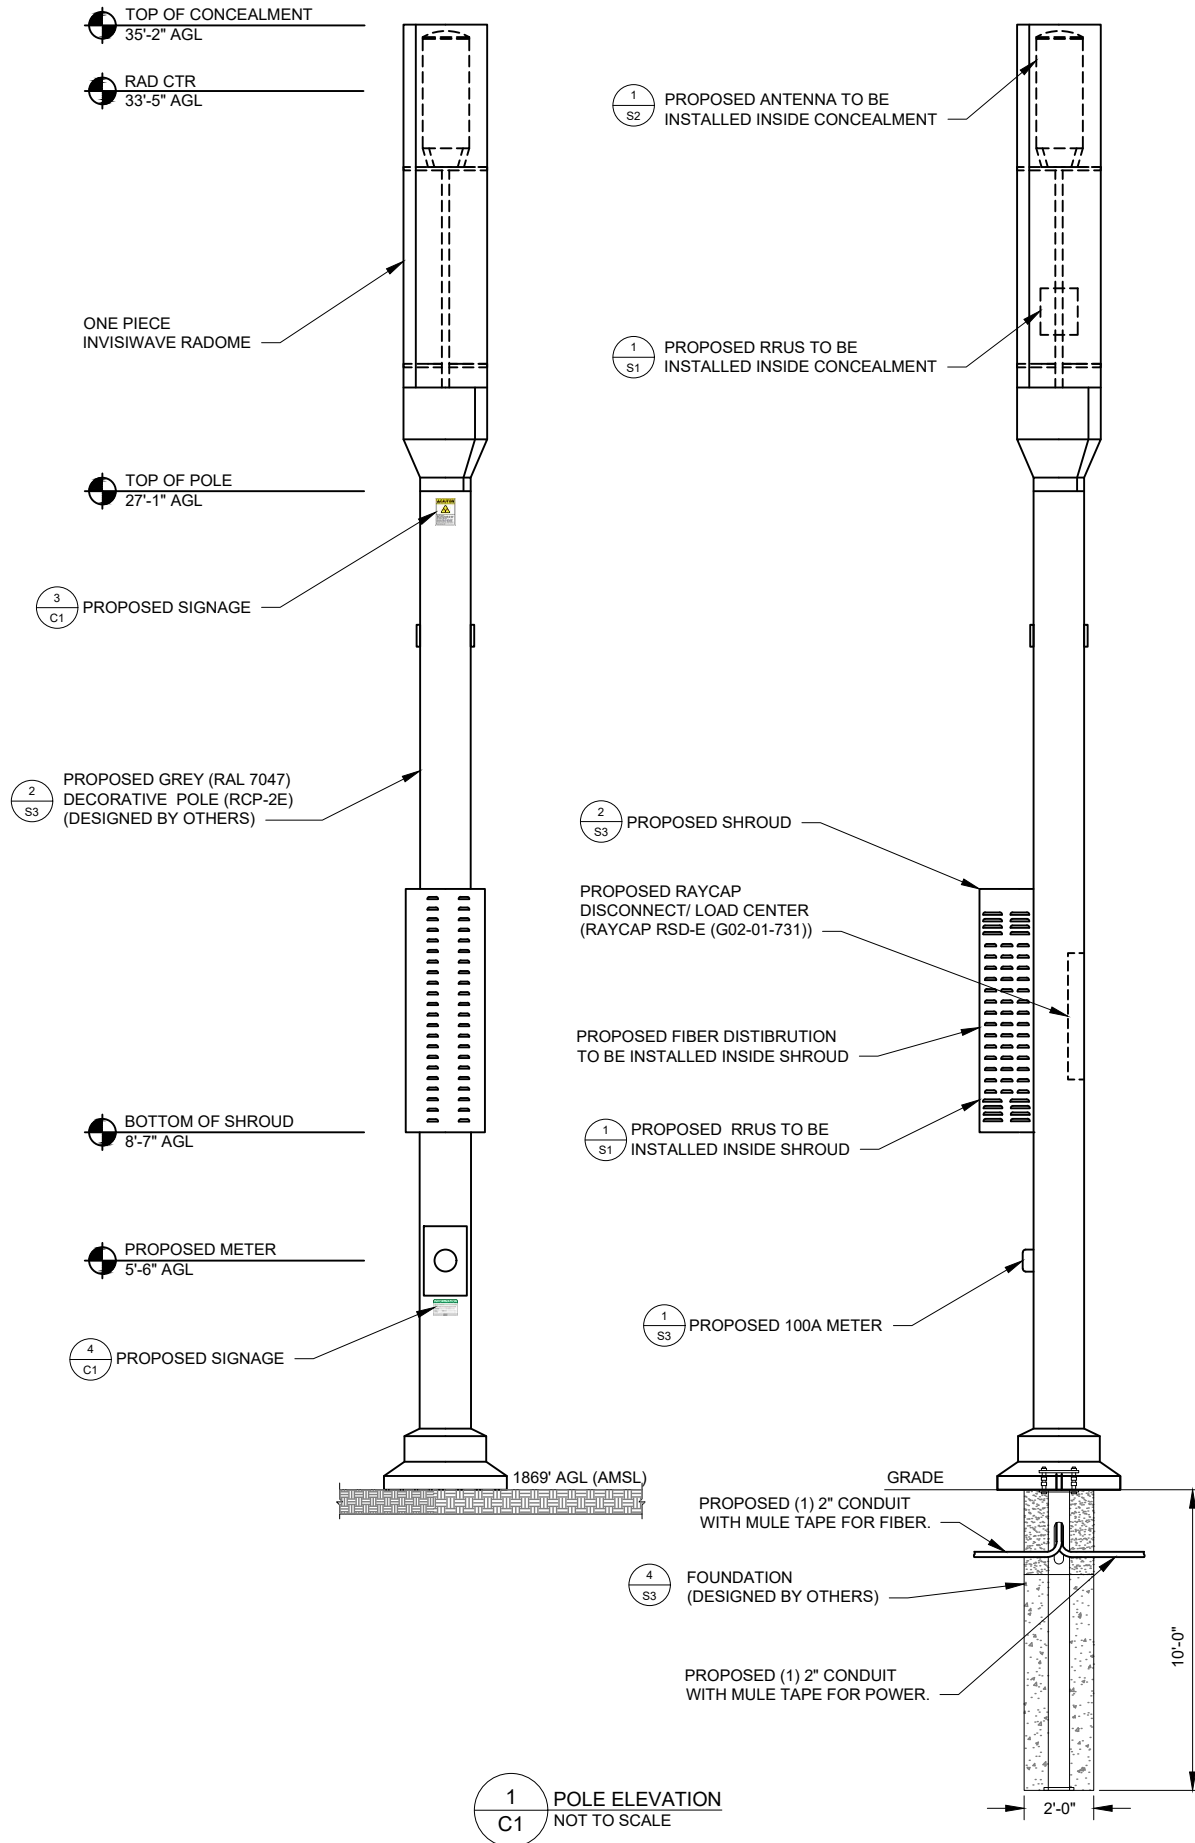


1 POLE ELEVATION
C1 NOT TO SCALE

ANTENNA SCHEDULE NOTES


1. CONTRACTOR TO MOUNT ANTENNAS PER MANUFACTURER'S SPECIFICATIONS
2. CONTRACTOR TO REFERENCE VZW ISSUED RFDS AND GIVE PRECEDENCE TO
3. INFORMATION PROVIDED IN RFDS OVER INFORMATION PROVIDED IN THIS TABLE
4. VERIFY LOADING WITH STRUCTURAL ANALYSIS PRIOR TO CONSTRUCTIONS

PROPOSED ANTENNA/FEEDLINES SCHEDULE						
MANUFACTURER (MODEL)	MOUNTING HEIGHT (RAD CTR)	COAX CABLE	HYBRID CABLE	AZIMUTH (TN)	DIPLEXER	COMBINERS / SPLITTERS
JMA WIRELESS CX160MI236	33'-5"	(12) 1/2" OAX	-	0°	1	-

2 ANTENNA SCHEDULE
C1

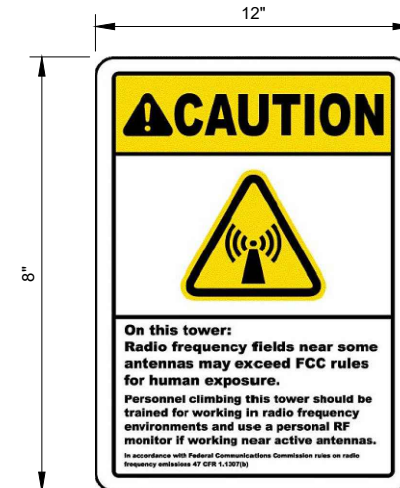

3 INFORMATION SIGN
C1

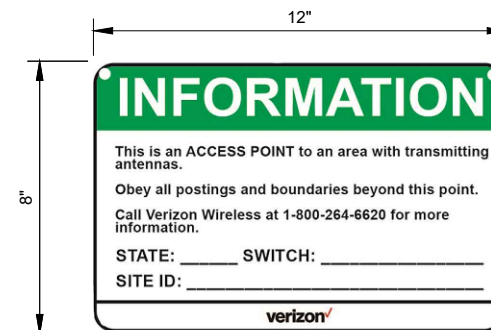

4 INFORMATION SIGN
C1

PREPARED FOR:
verizon
1000 WILLIAMS BLVD
KENNER, LA 70062

A&E FIRM:
towersource
1875 OLD ALABAMA ROAD, SUITE 1008
ROSWELL, GA 30076
TEL: 678-990-2338 FAX: 678-990-2342

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DRAWN BY: BA CHECKED BY: JKP

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PROJECT INFORMATION:
VERIZON SITE ID
SMC_CBRLD_MD_CTR_CRSVILE_1-SITERRA
NEAREST ADDRESS
396 S MAIN ST
CROSSVILLE, TN 38555
(CUMBERLAND COUNTY)


SHEET TITLE:
POLE ELEVATION

SHEET NO. **C1** REVISION: **0**

PREPARED FOR:
verizon[✓]
 1000 WILLIAMS BLVD
 KENNER, LA 70062

A&E FIRM:

 1875 OLD ALABAMA ROAD, SUITE 1008
 ROSWELL, GA 30076
 TEL: 678-990-2338 FAX: 678-990-2342

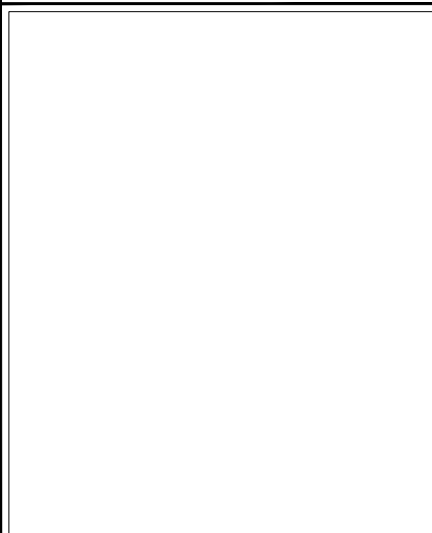


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 CTR_CRSVILE_1-SITERRA
 NEAREST ADDRESS
 396 S MAIN ST
 CROSSVILLE, TN 38555
 (CUMBERLAND COUNTY)

SHEET TITLE:
PHOTO SIMS

SHEET NO. **C2.1** | REVISION: **0**


CURRENT VIEW
 (FROM SW LOOKING NE)

PROPOSED VIEW
 (FROM SW LOOKING NE)

PREPARED FOR:
verizon^v
 1000 WILLIAMS BLVD
 KENNER, LA 70062

A&E FIRM:

 1875 OLD ALABAMA ROAD, SUITE 1008
 ROSWELL, GA 30076
 TEL: 678-990-2338 FAX: 678-990-2342

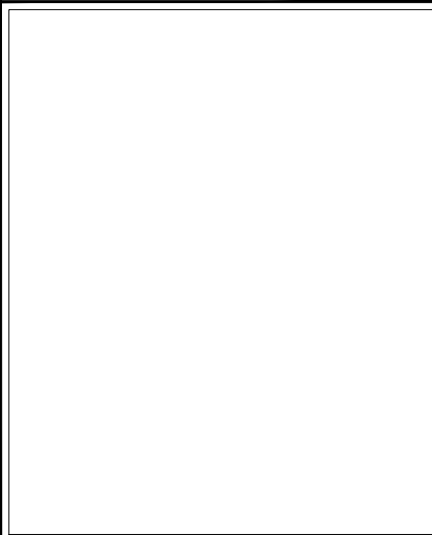

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 CTR_CRSVILE_1-SITERRA
 NEAREST ADDRESS
 396 S MAIN ST
 CROSSVILLE, TN 38555
 (CUMBERLAND COUNTY)

SHEET TITLE:
PHOTO SIMS

SHEET NO. **C2.2** | REVISION: **0**

CURRENT VIEW
 (FROM SW LOOKING NE)

PROPOSED VIEW
 (FROM SW LOOKING NE)

Notes for Figure 6H-33—Typical Application 33
Stationary Lane Closure on a Divided Highway

Standard:

1. This information also shall be used when work is being performed in the lane adjacent to the median on a divided highway. In this case, the LEFT LANE CLOSED signs and the corresponding Lane Ends signs shall be substituted.
2. When a side road intersects the highway within the TTC zone, additional TTC devices shall be placed as needed.

Guidance:

3. When paved shoulders having a width of 8 feet or more are closed, channelizing devices should be used to close the shoulder in advance of the merging taper to direct vehicular traffic to remain within the traveled way.

Option:

4. A truck-mounted attenuator may be used on the work vehicle and/or shadow vehicle.

Support:

5. Where conditions permit, restricting all vehicles, equipment, workers, and their activities to one side of the roadway might be advantageous.

Standard:

6. An arrow board shall be used when a freeway lane is closed. When more than one freeway lane is closed, a separate arrow board shall be used for each closed lane.

Figure 6H-33. Stationary Lane Closure on a Divided Highway (TA-33)

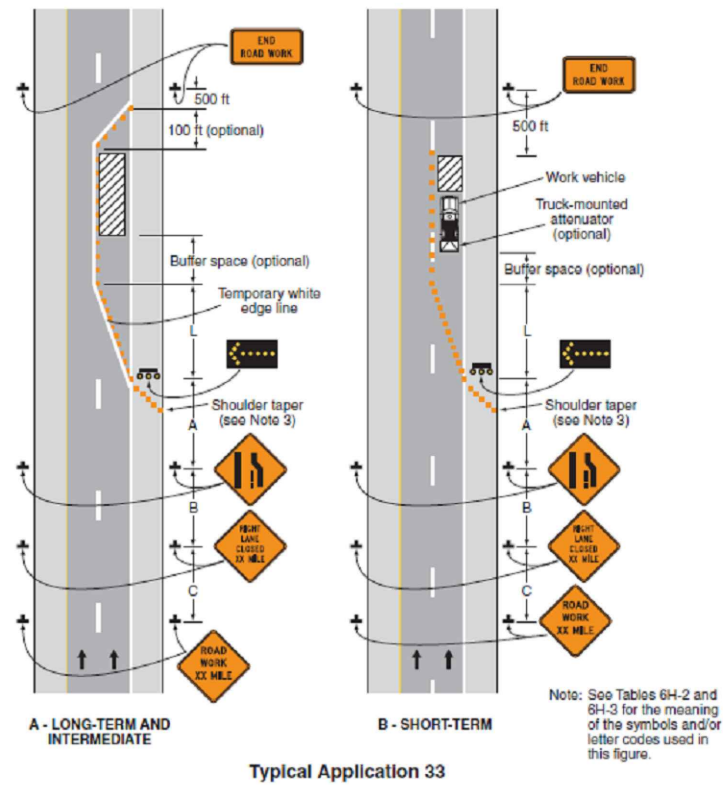


Table 6H-2. Meaning of Symbols on Typical Application Diagrams

	Arrow board		Shadow vehicle
	Arrow board support or trailer (shown facing down)		Sign (shown facing left)
	Changeable message sign or support trailer		Surveyor
	Channelizing device		Temporary barrier
	Crash cushion		Temporary barrier with warning light
	Direction of temporary traffic detour		Traffic or pedestrian signal
	Direction of traffic		Truck-mounted attenuator
	Flagger		Type 3 barricade
	High-level warning device (Flag tree)		Warning light
	Longitudinal channelizing device		Work space
	Luminaire		Work vehicle
	Pavement markings that should be removed for a long-term project		

Table 6H-4. Merging Taper Lengths and Spacing of Channelizing Devices

Posted Speed	Formula	* Minimum Desirable Taper Lengths			Suggested maximum Spacing of Channelizing Devices	
		10' Offset	11' Offset	12' Offset	On a taper	On a tangent
30	$L = WS^2 / 60$	150'	165'	180'	30'	60'
35		205'	225'	245'	35'	70'
40		265'	295'	320'	40'	80'
45	L = WS	450'	495'	540'	45'	90'
50		500'	550'	600'	50'	100'
55		550'	605'	660'	55'	110'
60		600'	660'	720'	60'	120'
65		650'	715'	780'	65'	130'
70		700'	770'	840'	70'	140'
75		750'	825'	900'	75'	150'
80		800'	880'	960'	80'	160'

* Taper lengths have been rounded off.
L = Length of Taper (Feet) W = Width of Offset (Feet) S = Posted Speed (MPH)

Table 6H-3. Suggested Advance Warning Sign Spacing

Road Classification	Posted Speed (MPH)	Sign Spacing "X" (Feet)
Conventional Highway	25	100
	30	120
	35	160
	40	240
	45	320
	50	400
	55*	500
	60*	600
	65*	700
Expressway or Freeway	70*	800
	75*	900
	80*	1000
	All Speeds	See Typical Applications **

* Distance between signs should be increased to have 1500 feet advance warning. (See Section 6C.04.07)

** Distance between signs should be increased to have 1/2 mile or more advance warning (See Section 6C.04.05)



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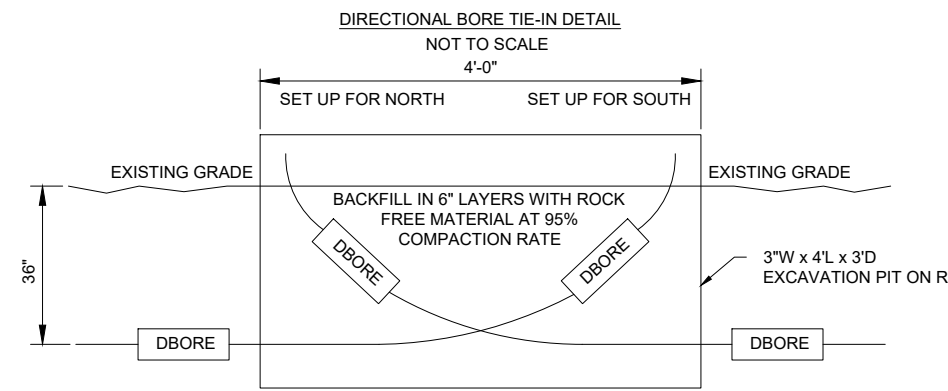
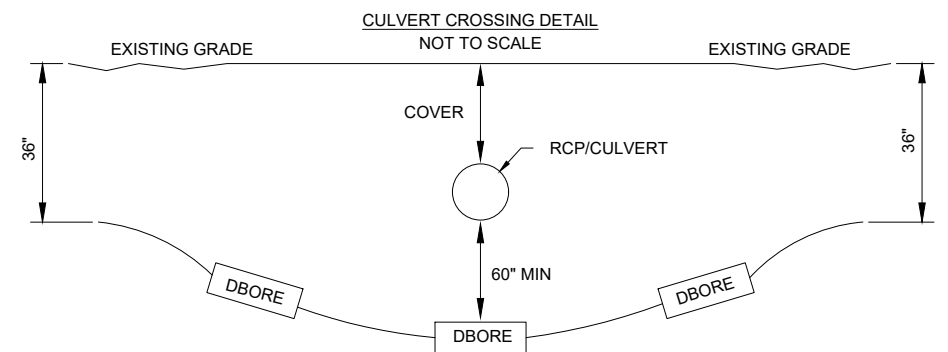
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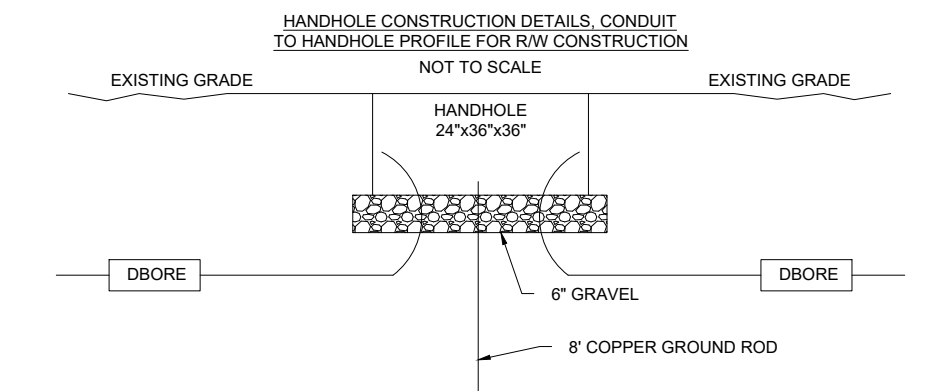
PROJECT INFORMATION:
VERIZON SITE ID
SMC_CBRLD_MD_
CTR_CRSVILE_1-SITERRA
NEAREST ADDRESS
396 S MAIN ST
CROSSVILLE, TN 38555
(CUMBERLAND COUNTY)

SHEET TITLE:
TRAFFIC CONTROL

SHEET NO. **C3** REVISION: **0**




- TIE-IN STATION**
1. BORE FROM EACH DIRECTION IS RUN AT DESIGN DEPTH TO 2 FEET PAST THE INTENDED TIE-IN THEN TURNED UP TO DAYLIGHT.
 2. THE TIE-IN POINT IS EXCAVATED. THE CONDUITS CUT OFF WHERE THEY CROSS EACH OTHER AT DESIGN DEPTH, AND COUPLER IS INSTALLED TO CONNECT THE TWO CONDUITS AT THE DESIGN DEPTH.
 3. ALL EXCAVATIONS OR TRENCHES 4 FEET OR GREATER IN DEPTH SHALL BE APPROPRIATELY BENCHED, SHORED, OR SLOPED IN OSHA'S EXCAVATIONS STANDARD, 29 CFR 1926.650, .651, AND .652




- TIE-IN STATION**
1. ALL EXCAVATIONS OR TRENCHES 4 FEET OR GREATER IN DEPTH SHALL BE APPROPRIATELY BENCHED, SHORED, OR SLOPED ACCORDING TO THE PROCEDURES AND REQUIREMENTS SET FORTH IN OSHA'S EXCAVATION STANDARDS, 29 CFR 1926.650, .651, AND .652.

1 STANDARD BORE PIT DETAILS
NOT TO SCALE

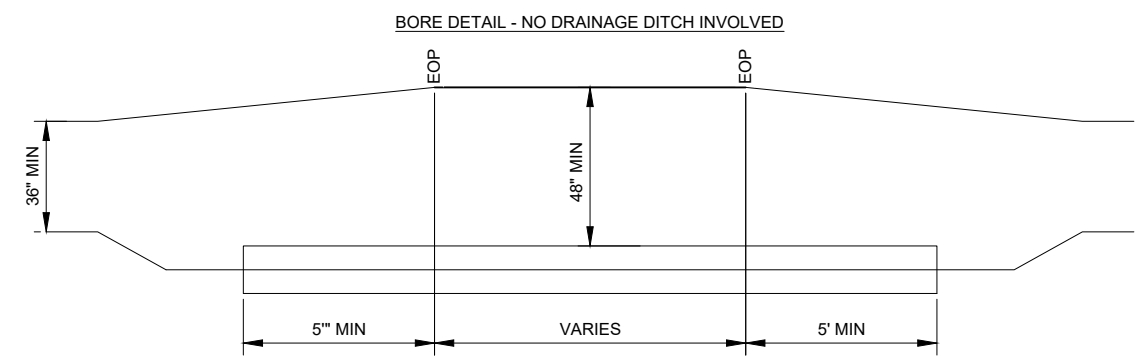


2 STANDARD BORE DETAILS
NOT TO SCALE

- NOTES**
1. ACTUAL SEPARATION OF CONDUITS TO BE DETERMINED BY SITE SPECIFIC REQUIREMENTS
 2. PROVIDE PVC CONDUIT BELOW GRADE EXCEPT AS NOTED BELOW
 3. PROVIDE RGS CONDUIT AND ELBOWS AT STUB UP LOCATION (I.E. SERVICE POLES, EQUIPMENT, ETC.)
 4. PROVIDE RGS CONDUIT FOR INSTALLATION BELOW PARKING LOTS AND ROADWAYS

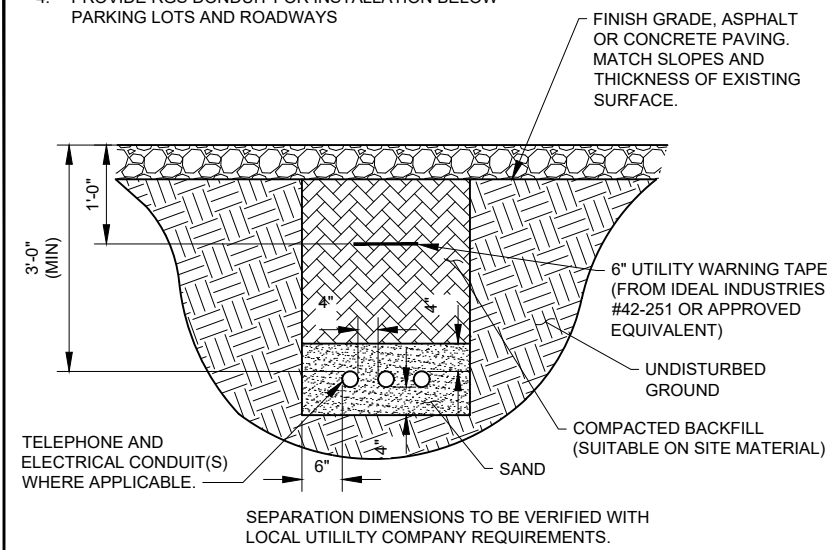

3 CONDUIT TRENCHING DETAILS
NOT TO SCALE

- NOTES**
1. INSTALL ON 3/4" AGGREGATE WHICH SHALL EXTEND A MINIMUM OF 6" BEYOND ALL SIDES OF THE BOX AND BE A MINIMUM OF 4" DEEP, BELOW THE BOX
 2. OLDCASTLE ENCLOSURE SOLUTIONS (P/N: OLDCASTLE POLYMER 1730-18 TIER 22) MODEL NUMBER: 17301031
 3. CAP TO HAVE POWER/ELEC OR TELCO SHOWN

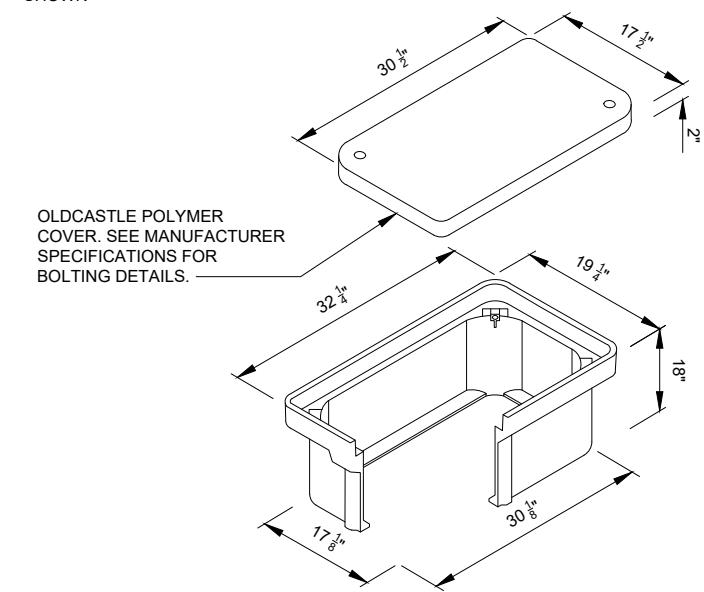

4 HANDHOLE DETAILS
NOT TO SCALE

PREPARED FOR:

1000 WILLIAMS BLVD
KENNER, LA 70062

A&E FIRM:

1875 OLD ALABAMA ROAD, SUITE 1008
ROSWELL, GA 30076
TEL: 678-990-2338 FAX: 678-990-2342

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CTR_CRSVILE_1-SITERRA

NEAREST ADDRESS
396 S MAIN ST
CROSSVILLE, TN 38555
(CUMBERLAND COUNTY)

SHEET TITLE:
DETAILS


SHEET NO. **C4** REVISION: **0**

PROPOSED PANEL SCHEDULE			
LOAD SERVED	VOLT AMPERERS (WATTS)		AMP / POLE
	L1	L2	
100A MAIN BREAKER	N/A	--	100A
PSU 1 & 2	2880	--	15 / 15
PSU 3 & 4	--	2880	15 / 15
PANEL ANTENNA 1 & 2	2880	--	15 / 15
L1 VOLT AMPERES	5760		
L2 VOLT AMPERES	2880		
AMPS	48	38	
MAX AMPS + 25%	60		
MAX AMP +			

NOTES
 ONE LINE DIAGRAM AND GENERAL WIRING DIAGRAM DO NOT SHOW CORRECT NUMBER OF PSUs. THERE SHOULD BE 4E// PSU08s SHOWN, 2 FOR EACH DUAL BAND RAIDO.


1 POWER PANEL SCHEDULE
 E1 NOT TO SCALE

- CABLE SCHEDULE**
- 1 2 - #3 AWG THHN & #4 GROUND
REFER TO UTILITY POLE ELEVATION FOR CONDUIT SIZES
 - 2 3 - #14 AWG & #6 GROUND
REFER TO UTILITY POLE ELEVATION FOR CONDUIT SIZES

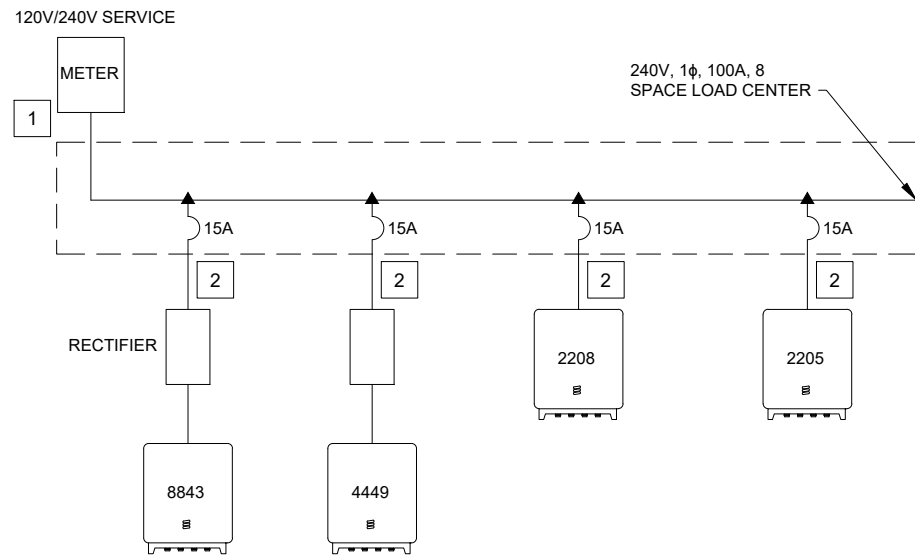

- ONE LINE DIAGRAM NOTES**
- 1 ELECTRICAL SERVICE SHALL BE 100A, 120/240V, 1Ø, 3W
 - 2 PROVIDE SERVICE ENTRANCE RATED CIRCUIT BREAKER TYPE SERVICE DISCONNECT. (1Ø, 3W, 240V, 100A, WITH CIRCUIT BREAKER RATED AT 100A)
 - 3 INSTALL A 100 AMP METER BASE AS DIRECTED BY THE UTILITY COMPANY
 - 4 SOME BREAKERS NOT SHOWN IN ONE LINE DIAGRAM FOR CLARITY

2 ONE LINE DIAGRAM
 E1 NOT TO SCALE

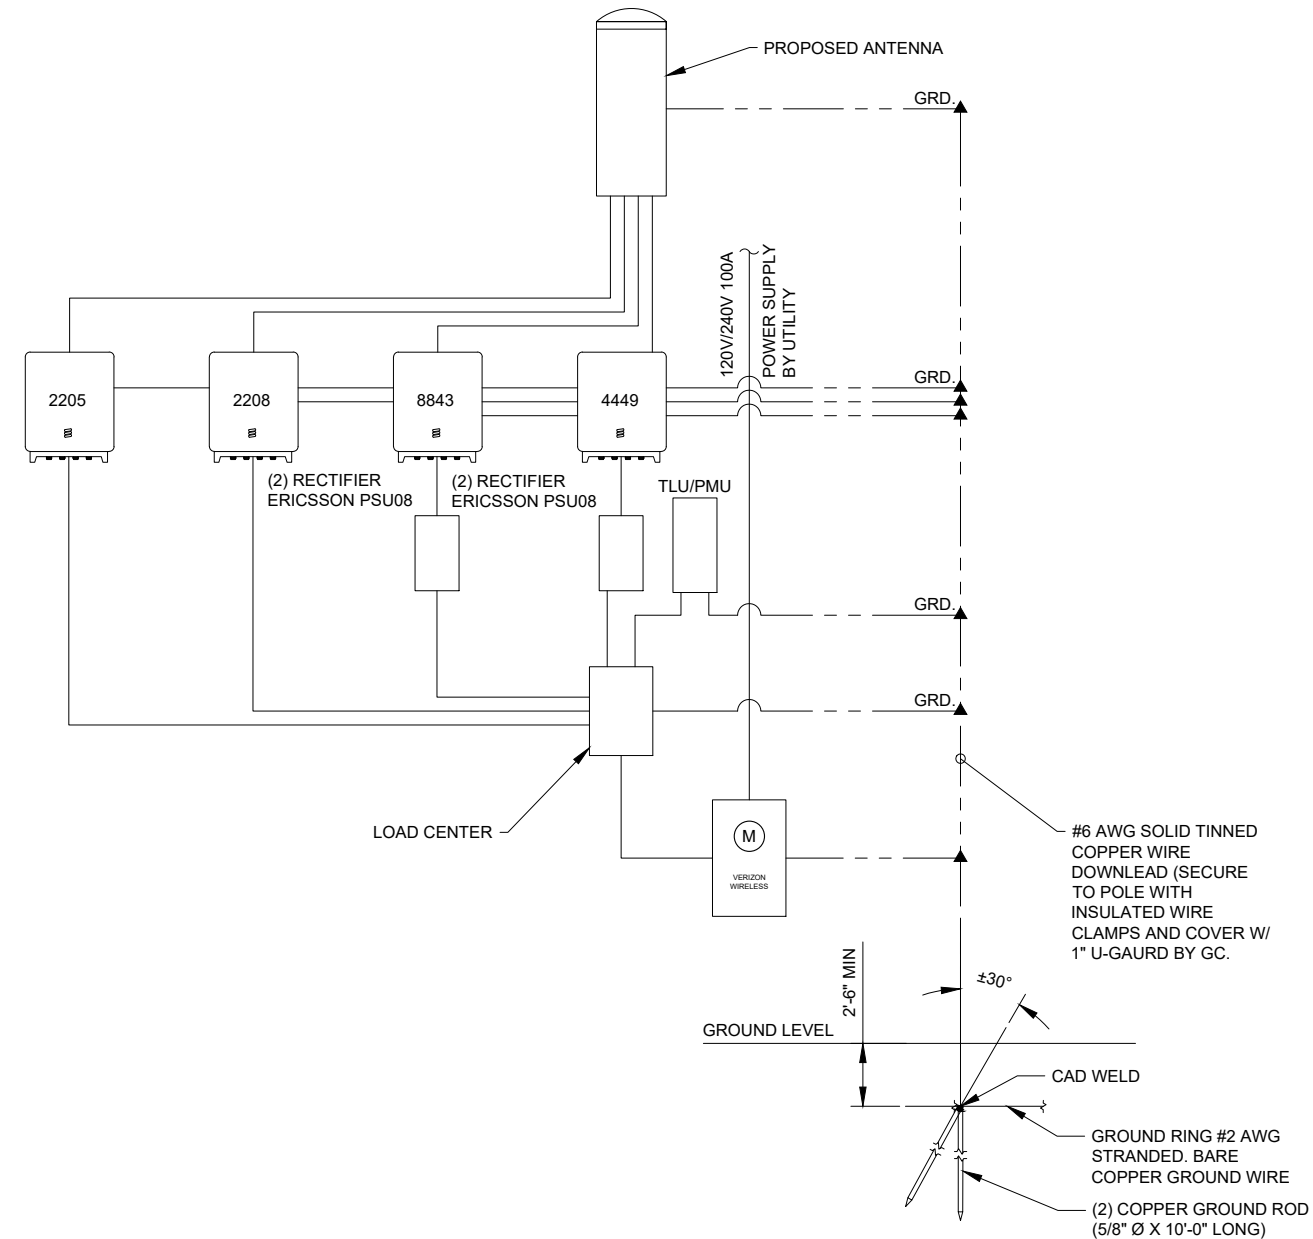

3 GENERAL WIRING DIAGRAM
 E1 NOT TO SCALE

PREPARED FOR:
verizon
 1000 WILLIAMS BLVD
 KENNER, LA 70062

A&E FIRM:
towersource
 1875 OLD ALABAMA ROAD, SUITE 1008
 ROSWELL, GA 30076
 TEL: 678-990-2338 FAX: 678-990-2342

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NEAREST ADDRESS
 396 S MAIN ST
 CROSSVILLE, TN 38555
 (CUMBERLAND COUNTY)

SHEET TITLE:
ONE LINE DIAGRAM

SHEET NO. **E1** | REVISION: **0**

Antenna Summary

Added Antennas														
700 LTE	850 CDM A	850 LTE	1900 CDM A	1900 LTE	2100 LTE	Make	Model	Centerline	Tip Height	Azimuth	RET	4xRx	Inst. Type	QTY
YES		YES		YES	YES	JMA WIRELESS	CX160MI236	40	41.4	0(D1)	true	true	PHYSICAL	1

Removed Antennas														
700 LTE	850 CDM A	850 LTE	1900 CDM A	1900 LTE	2100 LTE	Make	Model	Centerline	Tip Height	Azimuth	RET	4xRx	Inst. Type	QTY

Retained Antennas														
700 LTE	850 CDM A	850 LTE	1900 CDM A	1900 LTE	2100 LTE	Make	Model	Centerline	Tip Height	Azimuth	RET	4xRx	Inst. Type	QTY


Added: 1 Removed: 0 Retained: 0

Equipment Summary

Added Non Antennas													
Equipment Type	700 LTE	850 CDMA	850 LTE	1900 CDMA	1900 LTE	2100 LTE	Location	Make	Model	Cable Length	Cable Size	Inst. Type	Quantity
RRU							Tower	Ericsson	2205 - Near the Antenna			PHYSICAL	1
RRU							Tower	Ericsson	2208 - Near the Antenna			PHYSICAL	1
RRU	YES		YES				Tower	Ericsson	4449 - Mounted inside Equipment Shroud at the bottom of the pole			PHYSICAL	1
RRU					YES	YES	Tower	Ericsson	8843 - Mounted inside Equipment Shroud at the bottom of the pole			PHYSICAL	1
Diplexer					YES	YES	Tower	JMA Wireless	DBCC-AW-P-4WF (Compact Diplexer AWS-PCS Quad)			PHYSICAL	1
Coaxial Cables							Tower	CommScope	FSJ1-50A or equivalent		1/2"	PHYSICAL	12

Removed Non Antennas													
Equipment Type	700 LTE	850 CDMA	850 LTE	1900 CDMA	1900 LTE	2100 LTE	Location	Make	Model	Cable Length	Cable Size	Inst. Type	Quantity

Retained Non Antennas													
Equipment Type	700 LTE	850 CDMA	850 LTE	1900 CDMA	1900 LTE	2100 LTE	Location	Make	Model	Cable Length	Cable Size	Inst. Type	Quantity

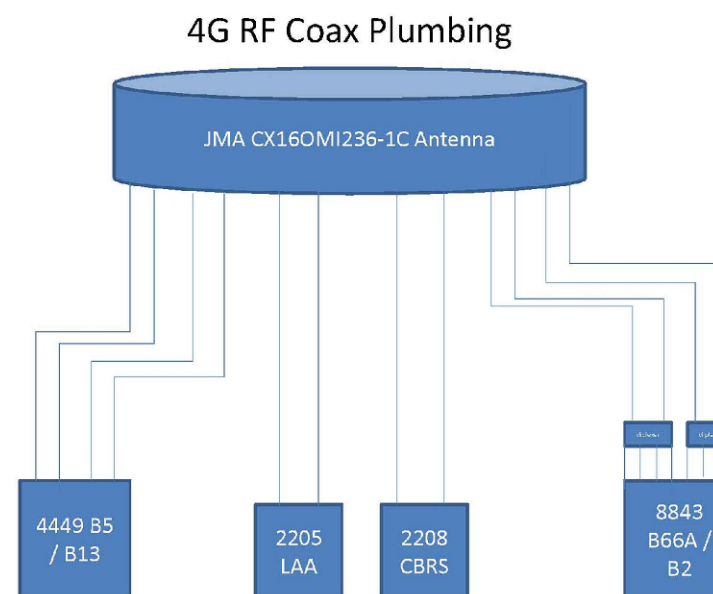

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 NEAREST ADDRESS
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 CROSSVILLE, TN 38555
 (CUMBERLAND COUNTY)

SHEET TITLE:
RFDS & PLUMBING DIAGRAM



SHEET NO. **E2** REVISION: **0**

GROUNDING NOTES

1. CONTRACTOR TO VERIFY THAT GROUNDING ELECTRODES SHALL BE INTERCONNECTED IN A GROUNDING SYSTEM USING #2 AWG BARE TINNED COPPER WIRE. THE TOP OF THE GROUND RODS AND GROUNDING CONDUCTORS TO BE 30 INCHES BELOW FINISHED GRADE. GROUNDING ELECTRODES SHALL BE DRIVEN ON 10'-0" CENTERS MINIMUM. (15'-0" MAXIMUM, PROVIDE AND INSTALL AS REQUIRED PER PLAN)
2. BONDING OF THE GROUNDED CONDUCTOR (NEUTRAL) AND THE GROUNDING CONDUCTOR SHALL BE AT THE SERVICE DISCONNECTING MEANS. BONDING JUMPER SHALL BE INSTALLED PER N.E.C. ARTICLE 250.30.
3. GROUNDING SYSTEM CONDUCTORS SHALL BE OF EQUAL LENGHT, MATERIAL, AND BONDING TECHNIQUE.
4. CONTRACTOR TO INSURE THAT THE GROUND ROD IS WITHIN 12 TO 36 INCHES OF THE POLE FOUNDATION. CONTRACTOR TO VERIFY ALL EXISTING SITE GROUNDING CONDITIONS BEFORE STARTING WORK OR PURCHASING EQUIPMENT.
5. BONDING CONDUCTORS SHALL BE ROUTED THROUGH A 3/4" PVC CONDUIT SLEEVE RUN UNDER THE FOUNDATION. REFER TO THE GROUNDING PLAN.

NOTES


MINIMUM SPACING OF 12" BETWEEN ALL CADWELDS

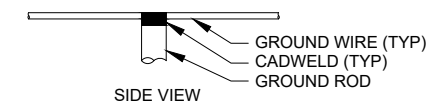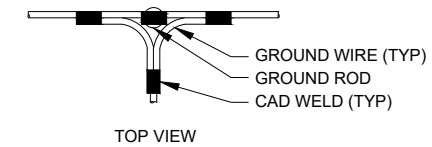

2 CADWLED GROUNDING DETAIL
E3 NOT TO SCALE

NOTES

GROUND BAR SHALL BE SIZED TO ACCOMODATE ALL GROUNDING CONNECTIONS REQUIRED PLUS PROVIDE 50% SPARE CAPACITY

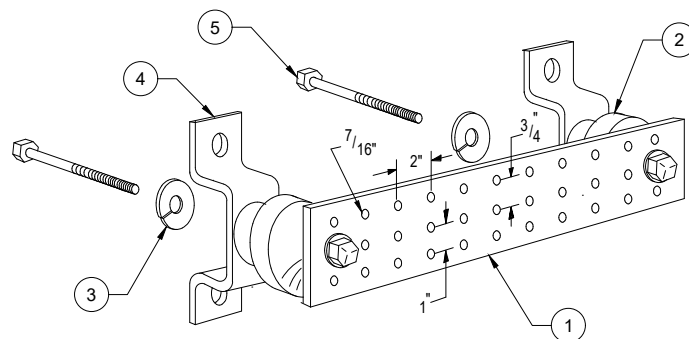


LEGEND

- 1 COPPER GROUND BAR, 1/4" x 4" x 20" MIN NEWTON INSTRUMENT CO. (CAT. # B-6142) HOLE CENTERS TO MATCH NEMA DOUBLE LUG CONFIGURATION
- 2 INSULATORS NEWTON INSTRUMENT CO. (CAT. # 3061-4)
- 3 5/8" LOCKWASHER NEWTON INSTRUMENT CO. (CAT. # 3015-8)
- 4 WALL MOUNTING BRACKET, NEWTON INSTRUMENT CO. (CAT. # A-6056)
- 5 5/8"-11 x 1" H.H.C.S. BOLT, NEWTON INSTRUMENT CO. (CAT. # 3012-1)


1 GROUND BAR DETAIL
E3 NOT TO SCALE

LEGEND

- 1 PROPOSED GROUND ROD
- 2 2-HOLE MECHANICAL CONNECTION (TYP)
- 3 PROPOSED WOOD POLE
- 4 PROPOSED METER
- 5 GROUND TO PROPOSED PANEL ANTENNAS
- 6 PROPOSED GROUND RCO, GROUND ROD TO BE NO CLOSER THAN 6" TO SECONDARY PROPOSED GROUND ROD
- 7 PROPOSED EXOTHERMIC CADWELD OR IRREVERSIBLE CONNECTION USED FOR DIRECT CONTACT

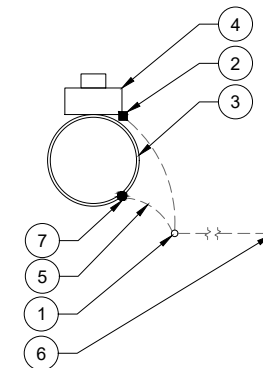

3 POLE GROUNDING PLAN
E3 NOT TO SCALE

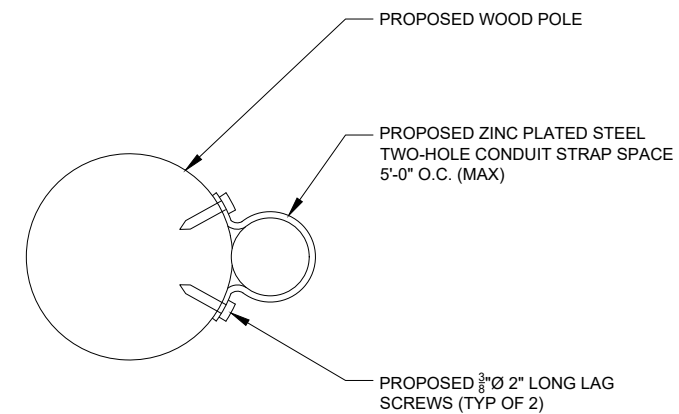

4 CONDUIT STRAP DETAIL
E3 NOT TO SCALE

PREPARED FOR:
verizon
1000 WILLIAMS BLVD
KENNER, LA 70062

A&E FIRM:
towersource
1875 OLD ALABAMA ROAD, SUITE 1008
ROSWELL, GA 30076
TEL: 678-990-2338 FAX: 678-990-2342

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DRAWN BY: BA | CHECKED BY: JKP

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PROJECT INFORMATION:
VERIZON SITE ID
SMC_CBRLD_MD_
CTR_CRSVILE_1-SITERRA

NEAREST ADDRESS
396 S MAIN ST
CROSSVILLE, TN 38555
(CUMBERLAND COUNTY)

SHEET TITLE:
GROUNDING DETAILS

SHEET NO. **E3** | REVISION: **0**

RADIO 4449 – B13 & B5 4TX 4RX PER BAND

- 4 antenna ports, 4TX/4RX for 2 bands with common RF ports
- Up to 320W RF Power shared between 2 bands
 - Examples:
 - 4x40W on each band or
 - 2x60W each band on two high-power RF ports
- Carrier Capacity:**
 - Up to 24 carrier and up to 10+25 MHz OBW for LTE
- 2 x 10 Gbps CPRI
- Size and Weight:**

Radio 4449 - B13& B5	Height	Width	Depth	Weight
w/ protruding items	15 in (380 mm)	13.2 in (335 mm)	9.3 in (235 mm)	70 lbs (31.7 Kg)
w/ protruding items	18 in (455 mm)	13.2 in (335 mm)	9.4 in (240 mm)	

- 48 VDC
- 2x20A fuse (2 power connectors, 2 or 3 wire)
- AISG TMA & RET support (2 Bias-T, 1 ALD port)
- Type 4.3-10 RF connectors
- 2 external alarms
- IP 65, -40 to +55 C

Now confirmed max measurements/ will not exceed



Portrait Mount Only



RADIO 2205 LAA

- 2TX/2RX
- 2x 0.5 W
- 60 MHz IBW
- Up to 3 20 MHz LTE carriers
- 2x10Gbps CPRI
- 4 liter, less than 11.03 lbs (5Kg) incl bracket and cover
- AC or -48 VDC
- Size HxWxD:
 - 7.88x7.88x3.94 in (200x200x100 mm) with cover
 - 4.69 in (119 mm) with high band antenna
 - Weight: 11.024 lbs (5Kg) including bracket and cover
- Integrated or external antenna
- 2 external alarm
- IP 65
- 40 to +55°C
- Operating Band
 - 5 GHz, LAA



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RADIO 8843 – B2 & B66A 4TX 4RX PER BAND

- 8 antenna ports, 4TX/4RX for 2 bands with separate RF ports
- Up to 320W RF Power shared between 2 bands
 - Examples:
 - 4x40W on each band or
 - 4x20W on B2 and 4x60W on Band 66A
 - 2x60W on Band 2 and 2x60W on Band 66A
- Carrier Capacity:**
 - Up to 24 carrier and up to 60+70 MHz OBW for LTE
- 2 x 10 Gbps CPRI
- Size and Weight:**

Radio 8843 - B2 & B66A	Height	Width	Depth	Weight
w/ protruding items	15 in (380 mm)	13.2 in (335 mm)	11.1 in (282 mm)	75 lbs (34.02 Kg)
w/ protruding items	18 in (455 mm)	13.2 in (335 mm)	11.3 in (287 mm)	

- 48 VDC
- 2x26A fuse (2 power connectors, 2 or 3 wire) (26A for 4x60W)
- AISG TMA & RET support (2 Bias-T, 1 ALD port)
- Type 4.3-10 RF connectors
- 2 external alarms
- IP 65, -40 to +55 C

Now confirmed max measurements/ will not exceed



Portrait Mount Only

RADIO 2208 B48 - CBRS

Capacity and Specifications	
- 3GPP: B48	- 3 LTE carriers
- 2TX/2RX	- Output Power 2x10 W
- 4TX/4RX by use of 2x2208	
- 60 MHz IBW	

Other Specifications	
- AC or -48 VDC	- 2 external alarm
- Integrated or external antenna	- IP 65, -40 to +55°C
- 3.5 GHz	- 2x 10Gbps CPRI

Size and Weight				
Radio 2208 (1 unit)	Height	Width	Depth	Weight
With Integrated Antenna	8.43 In	7.88 In	4.8 In	12.1 lbs



PROJECT INFORMATION:
 VERIZON SITE ID
 SMC_CBRLD_MD_
 CTR_CRSVILE_1-SITERRA
 NEAREST ADDRESS
 396 S MAIN ST
 CROSSVILLE, TN 38555
 (CUMBERLAND COUNTY)

SHEET TITLE:
RRUS SPECS

SHEET NO. **S1** | REVISION: **0**



CX16OMI236-1C NWAV™ X-Pol Omni Antenna

- 16-port 2 ft 360° antenna with RET-controlled HB: 4 ports 898-960 MHz, 4 ports 1695-2700 MHz, 4 ports 3550-3700 MHz, and 4 ports 5150-5925 MHz
- X-Pol, Small Cell, hex-port antenna
- Suitable for pole or building mount
- 4x4 MIMO low-band, 4x4 MIMO for each AWS/PCS/CRS/LA
- Internal beam combining
- Dependent RET control for 1695-2700 MHz frequencies
- Suitable for LTE/UMTS/CDMA/GSM technologies
- Cost-effective solution for neutral host locations

Electrical specification (min/max)	Ports 1, 2, 3, 4				Ports 5, 6, 7, 8			
Frequency bands, MHz	698-738	824-860	1695-1880	1800-1900	1920-2180	2300-2500	2500-2700	
Polarization	± 45°				± 45°			
Average gain over all 360°, dBi	3.5	3.5	9.0	9.2	9.9	10.1	9.9	
Horizontal beamwidth (HBW), degrees	360°				360°			
Vertical beamwidth (VSW), degrees ¹	80°	60°	15.4°	14.4°	13.5°	12.0°	11.0°	
Electrical downtilt (EDT) range, degrees	0° (RET)				2-8° (RET)			
Cross-polar isolation, port-to-port, dB ²	25	25	25	25	25	25	25	
Max VSWR / return loss, dB	1.5:1 / -14.0				1.5:1 / -14.0			
Max PIM, 2x20W carrier, dBc	-153				-153			
Maximum input power per port, watts	250				125			
Maximum composite power, watts	900							



Electrical specification (min/max)	Ports 9, 10, 11, 12				Ports 13, 14, 15, 16			
Frequency bands, MHz	3550-3700	5150-5250	5250-5350	5470-5725	5725-5950	5950-5925		
Polarization	± 45°				± 45°			
Average gain over all 360°, dBi	5.0	5.5	5.7	5.5	5.5	5.6		
Horizontal beamwidth (HBW), degrees	360°				360°			
Vertical beamwidth (VSW), degrees ¹	28°	24°	24°	20°	14°	18°		
Electrical downtilt (EDT) range, degrees	0° (RET)				0° (RET)			
Cross-polar isolation, port-to-port, dB ²	25	25	25	25	25	25		
Max VSWR / return loss, dB	1.5:1 / -14.0				1.5:1 / -14.0			
Max PIM, 2x20W carrier, dBc	N/A				N/A			
Maximum total input power, watts	50	0.5	0.125	0.125	0.5	0.5		

¹ Typical value over frequency and tilt. Note: Vertical beam upper side lobe at 5150-5925 MHz < -15 dB at > 30° above horizon.
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CX16OMI236-1C NWAV™ X-Pol Omni Antenna

Mechanical specifications	
Dimensions height/diameter, inches (mm)	35.4" (900) / 14" (355)
Antenna volume (cubic feet)	2.98
No. of RF input ports, connector type, and location	16 x 4.3-10 female, bottom
RF connector torque	90 lbf-in (10.85 N-m or 8 lbf-ft)
Net antenna weight, lb (kg)	35 (15.9)
Rated wind survival speed, mph (km/h)	150 (241)
Frontal wind loading @ 150 km/h, lbf (N)	58.7 (261.2)
Equivalent flat plate @ 150 mph and Cd=2, sq ft	1.17



Small Cell solutions and mounting systems (sold separately)			
Side Arm Mounting System	SC-BKT-SA (color)	Wide Diameter Pole	SC-BKT-WTPE (color)
Site Pole Mounting System	SC-BKT-SLA (color)	Rooftop Ballasted Mounting System	DV-NLY-RTB (color)
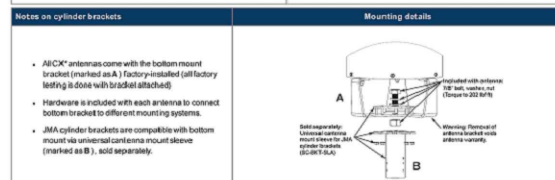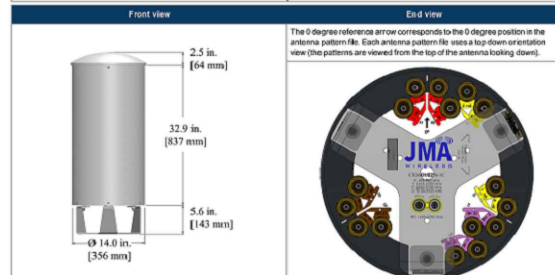
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1 ANTENNA SPECS
S2 NOT TO SCALE

Product Specifications

DBCC-AW-P-4BF

NWAV™ Dual-Band Compact Combiner



DBCC-AW-P-4BF

Dual-band compact combiner
1900/AWS-WCS
Quad design (4-unit) for 4TRx applications
4.3-10 connectors



- Combines PCS with AWS and/or WCS
- Compact size ideal for Small Cells and concealed applications
- Power handling can support macro radios up to 100W per port
- Low insertion loss and low PIM for optimized system performance
- Industry-leading connector technology for lasting performance
- Compatible with JMA WPS weatherproofing solution

Electrical specification	1900 passband	AWS/WCS passband
Passband	1800-1995	splitlink 1695-1760 downlink 2110-2360
Frequency, MHz		
Insertion loss, dB	0.2 dB Typ. 0.35 dB Max	
Return loss, dB min	20 dB	
Isolation to other bands, dB	45 dB typ. 40 dB Min	
Average input power per port CW, W max.	100	n/a 100
Combined total power CW, All ports, W max.	380	
Input peak envelope power (PEP), W max.	1500	n/a 1500
PIM 2x +43 dBm, dBc min.	-158	

Environmental specifications	
Environmental rating	ETSI EN 300 019 class 4.1, RoHS
Ingress protection	IP67, unmounted
Temperature range, °C	-40 to +65
Temperature range, °F	-40 to +149
Wind force @ 200 km/h (125 mph) front/side, lbf	13.42 / 6.97
Surge handling, all ports	RF port: ±10kA max. (8/20us), IEC 61000-4-5
Altitude	3,000 m max. 10,000 ft. max.
Mean time between failures (MTBF)	>10 ⁶

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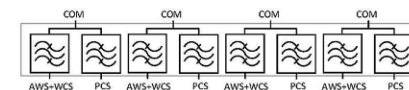
Product Specifications

DBCC-AW-P-4BF


NWAV™ Dual-Band Compact Combiner



Block diagram, Quad unit.



Mechanical specifications	
Connectors RF	4.3-10 (F)
Ground stud	M8 x 1 (hex nut included)
Connectors quantity	12
Dimensions, L x W x H mm (in.)	103 x 207 x 69 (4.07 x 8.17 x 2.73)
Weight, kg (lb) including brackets and HW	4.5 (9.9)
Mounting	Pole/wall bracket, two metal clamps for 45-178 mm diameter poles

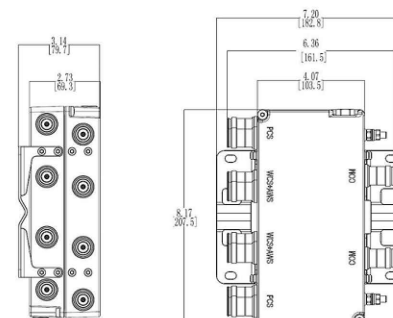

Ordering information	
DBCC-AW-P-4BF	2B empst comb AWS-WCS/PCS, Quad (4-unit)

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2 DIPLEXER SPECS
S2 NOT TO SCALE

PREPARED FOR:
verizon

1000 WILLIAMS BLVD
KENNER, LA 70062

A&E FIRM:
towersource

1875 OLD ALABAMA ROAD, SUITE 1008
ROSWELL, GA 30076
TEL: 678-990-2338 FAX: 678-990-2342

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VERIZON SITE ID
SMC_CBRLD_MD_CTR_CRSVILE_1-SITERRA
NEAREST ADDRESS
396 S MAIN ST
CROSSVILLE, TN 38555
(CUMBERLAND COUNTY)

SHEET TITLE:
EQUIPMENT SPECS

SHEET NO. S2 REVISION: 0



pe.eaton.com



Eaton meter socket

UTRS213BE

UPC:78685217758

Dimensions:

- Height: 15.11 IN
- Length: 4.48 IN
- Width: 11.22 IN

Weight: 14 LB

Warranties:

- Eaton Selling Policy 25-000, one (1) year from the date of installation of the Product or eighteen (18) months from the date of shipment of the Product, whichever occurs first.

Specifications:


- Type: Single-position residential service
- Amperage Rating: 200A
- Feed Type: Top/bottom
- Hub Type: 3-5/16 in hub opening
- Line: #6-350 kcmil
- Number Of Jaws: Four-jaw
- Phase: Single-phase
- Number Of Sockets: 1
- Number Of Wires: Three-wire
- Security: Ringless
- Voltage Rating: 600V

Supporting documents:

- Dimensional Drawing - METER SOCKET UTRS213(X)E, UGTRS213(X)E 200AMP, 1 @ OH/UG, RINGLESS STYLE
- Eaton Volume 1-Residential and Light Commercial
- Single Meter Sockets
- Eaton Specification Sheet - UTRS213BE

Certifications:

1 METER SPECS
S3 NOT TO SCALE

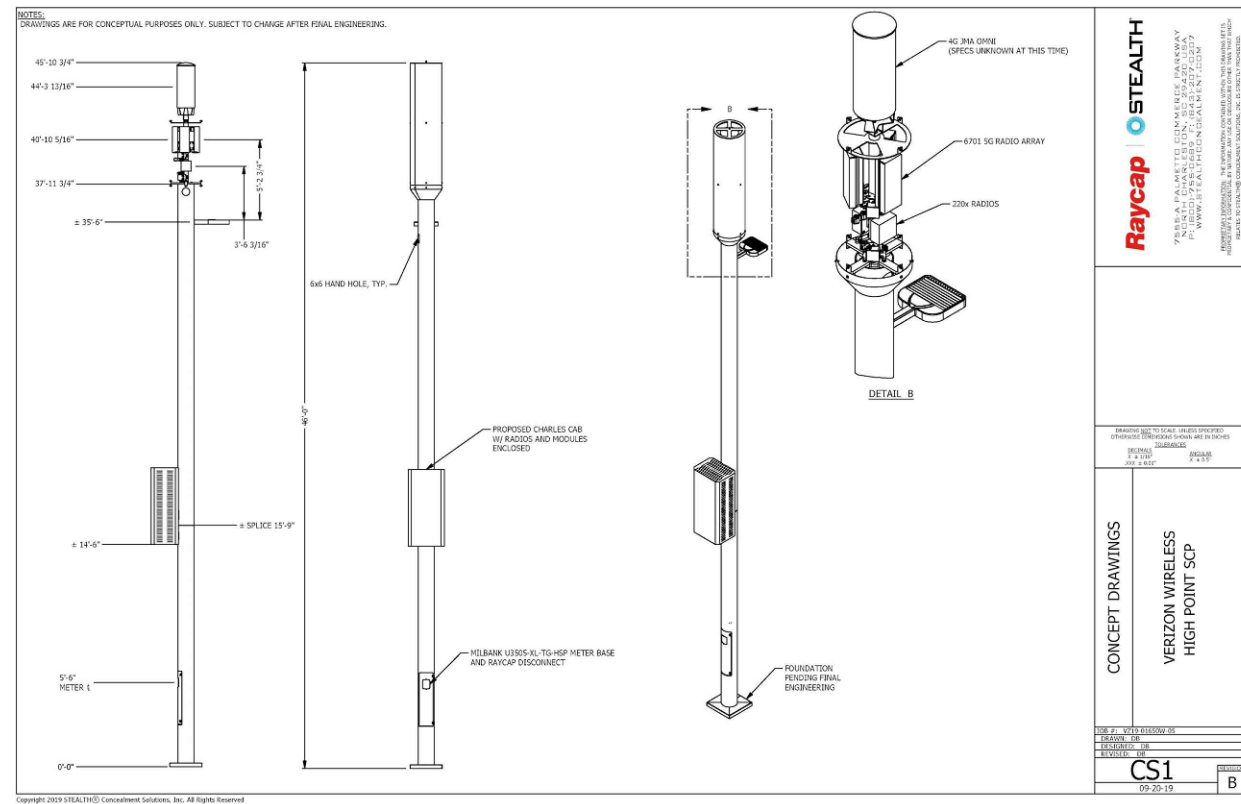


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RAL 7047


3 POLE SPECS
S3 NOT TO SCALE



ELEVATION VIEW

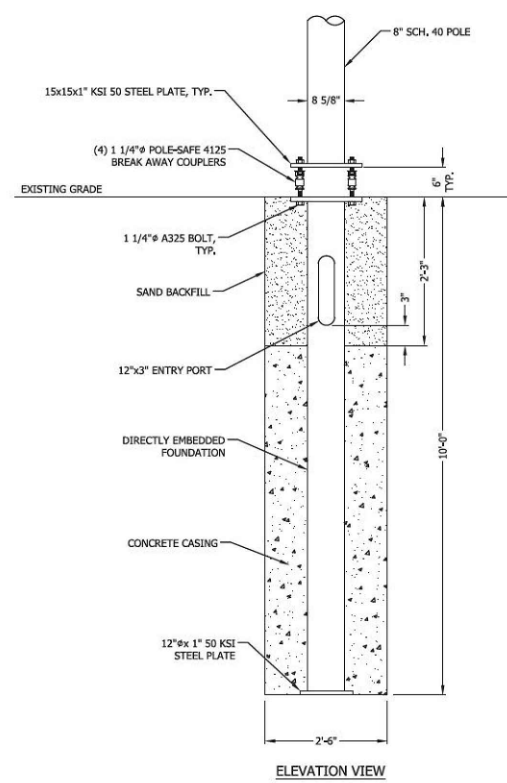4 FOUNDATION
S3 NOT TO SCALE

SHRD60 Concealment Shrouds
Small Cell / Densification Shrouds for Wireless Networks

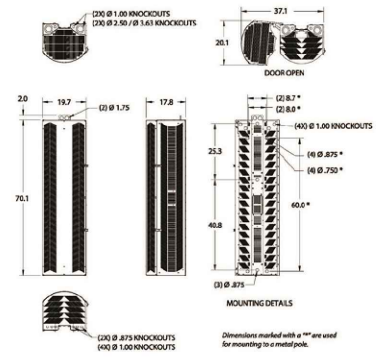

70" HIGH SH66-702018 DIMENSIONS (in.)

2 CONCEALMENT SHROUD
S3 NOT TO SCALE

PREPARED FOR:
verizon
1000 WILLIAMS BLVD
KENNER, LA 70062

A&E FIRM:
towersource
1875 OLD ALABAMA ROAD, SUITE 1008
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TEL: 678-990-2338 FAX: 678-990-2342

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