LTE 2C **CONSTRUCTION DRAWINGS**



AT&T SITE ID:

TOWER OWNER ID:

FA LOCATION:

KN6173

TN00324-B

10082962

SITE ADDRESS:

1011 OLD MAIL ROAD CROSSVILLE, TN 38555-4945 (CUMBERLAND COUNTY)



DIRECTIONS TO THE SITE

FROM GREENSBORO, NC:

START OUT GOING SOUTHWEST ON PISGAH CHURCH RD TOWARD LAWNDALE DR. TURN SLIGHT RIGHT ONTO BATTLEGROUND AVE/US-220 N. MERGE ONTO I-840 W VIA THE RAMP ON THE LEFT TOWARD I-73 N/WINSTON-SALEM. I-840 W BECOMES FUTURE I 840/I-73 S. MERGE ONTO I-40 W/US-421 N VIA EXIT 1 TOWARD WINSTON-SALEM. KEEP LEFT TO TAKE I-40 W TOWARD STATÉSVILLE/WINSTON-SALEM (CROSSING INTO TENNESSEE). TAKE THE TN-101/PEAVINE RD EXIT, EXIT 322, TOWARD CROSSVILLE. TURN LEFT ONTO PEAVINE RD/TN-101. STAY STRAIGHT TO GO ONTO TN-392. TURN LEFT ONTO COUNTRY OAKS DR. TURN LEFT ONTO OLD MAIL RD. SITE IS ON THE LEFT.

PROJECT DIRECTORY

SITE SUMMARY

CO-LOCATION

SELF SUPPORT

CUMBERLAND

126 034.03

VOLUNTEER ENERGY (423) 476-6571

(866) 620-6000

TELECOMMUNICATIONS

35° 55' 36.660" N (35.927)

85° 1' 22.050" W (-85.023)

CITY OF CROSSVILLE, TN

TOWER OWNER:

8051 CONGRESS AVE BOCA RATON, FL 33487 PHONE: (800) 487–7483

APPLICANT:

SITE TYPE:

TOWER TYPE:

COUNTY:

TOWER LATITUDE:

PARCEL NUMBER:

POWER COMPANY:

TELEPHONE COMPANY:

TOWER LONGITUDE:

ZONING JURISDICTION:

TYPE OF OCCUPANCY:

AT&T MOBILITY CORP. 2002 PISGAH CHURCH ROAD, SUITE 300 GREENSBORO, NC 27455

PHONE: (800) 638-2822

SITE DESIGNER:

FDH INFRASTRUCTURE SERVICES 6521 MERIDIEN DRIVE RALEIGH, NC 27616 CONTACT: DAMARIS SQUIRES

PHONE: (919) 755-1012

UNDERGROUND SERVICE ALERT

811

48 HOURS BEFORE YOU DIG



CODE COMPLIANCE

ALL WORK AND MATERIALS SHALL BE PERFORMED AND INSTALLED IN ACCORDANCE WITH THE CURRENT EDITIONS OF THE FOLLOWING CODES AS ADOPTED BY THE LOCAL GOVERNING AUTHORITIES. NOTHING IN THESE PLANS IS TO BE CONSTRUED TO PERMIT WORK NOT CONFORMING TO THE LATEST EDITIONS OF THE FOLLOWING

- 2012 INTERNATIONAL BUILDING CODE
- 2012 INTERNATIONAL FIRE CODE
- 2012 INTERNATIONAL PLUMBING CODE
- 2012 INTERNATIONAL EXISTING BUILDING CODE
- 2012 INTERNATIONAL FUEL GAS CODE
- 2012 INTERNATIONAL MECHANICAL CODE
- 2012 INTERNATIONAL PROPERTY MAINTENANCE CODE
- 2012 INTERNATIONAL ENERGY CONSERVATION CODE
- ANSI/TIA-222-G
- LOCAL BUILDING CODE
- CITY/COUNTY ORDINANCES
- FAA COMPLIANCE
- FCC COMPLIANCE

PROJECT DESCRIPTION

- REMOVE (6) ANTENNAS
- INSTALL (3) ANTENNAS
- REMOVE (6) TMAs
- INSTALL (3) RRUs

	SHEET INDEX		
SHEET NO.	DESCRIPTION	REV. NO.	REVISION DATE
T-1	TITLE SHEET	2	08/15/19
G-1	NOTES	2	08/15/19
C-1	EQUIPMENT LAYOUT PLANS	2	08/15/19
C-2	TOWER ELEVATION & ANTENNA LAYOUT PLANS	2	08/15/19
C-3	LEASED/EXISTING RF EQUIPMENT SCHEDULES	2	08/15/19
C-4	FINAL RF EQUIPMENT SCHEDULES	2	08/15/19
E-1	SINGLE LINE DIAGRAM	2	08/15/19
E-2	RISER DIAGRAM	2	08/15/19


GENERAL NOTES

THE FACILITY IS UNMANNED AND NOT FOR HUMAN HABITATION, THEREFORE HANDICAP ACCESS IS NOT REQUIRED. A TECHNICIAN WILL VISIT THE SITE AS REQUIRED FOR ROUTINE MAINTENANCE. THE PROJECT WILL NOT RESULT IN ANY SIGNIFICANT DISTURBANCE OR EFFECT ON DRAINAGE; NO SANITARY SEWER SERVICE, POTABLE WATER, OR TRASH DISPOSAL IS REQUIRED AND NO COMMERCIAL SIGNAGE IS PROPOSED.







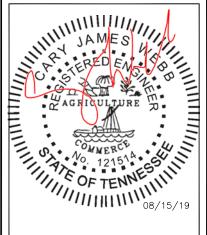

CARY J. WEBB, P.E. TENNESSEE LICENSE NO. 121514

DRAWN BY: DRS CHECKED BY: CJW APPV'D:

SUBMITTALS							
DATE	DESCRIPTION	REV	ISSUED BY				
08/08/19	CONSTRUCTION	0	DRS				
08/14/19	CONSTRUCTION	1	DRS				
08/15/19	CONSTRUCTION	2	DRS				

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AT&T SITE ID: KN6173

SITE ADDRESS 1011 OLD MAIL ROAD CROSSVILLE, TN 38555-4945

> FA LOCATION: 10082962

TOWER OWNER ID: TN00324-B

> SHEET TITLE: TITLE

SHEET SHEET NUMBER:

T-1

GENERAL NOTES:

- EVERY EFFORT HAS BEEN MADE IN THE CONSTRUCTION DOCUMENTS TO PROVIDE A
 COMPLETE SCOPE OF WORK. MINOR DISCREPANCIES IN THE DRAWINGS AND/OR
 SPECIFICATIONS SHALL NOT EXCUSE CONTRACTORS FROM COMPLETING THE PROJECT AND
 IMPROVEMENTS IN ACCORDANCE WITH THE INTENT OF THESE DOCUMENTS.
- 2. BIDDING REQUIREMENTS
 - a. PRIOR TO THE SUBMISSION OF BIDS, VISIT THE JOB SITE TO BECOME FAMILIAR WITH ALL CONDITIONS AFFECTING THE PROPOSED PROJECT. VISIT THE SITE WITH THE CONSTRUCTION DOCUMENTS TO VERIFY FIELD DIMENSIONS AND CONDITIONS TO CONFIRM THAT THE PROJECT WILL BE ACCOMPLISHED AS SHOWN.
 - b. PROVIDE NOTIFICATION TO OWNER'S REPRESENTATIVE IN WRITING OF ANY CONFLICTS, ERRORS, OR OMISSIONS PRIOR TO SUBMISSION OF PRICE PROPOSAL. IN THE EVENT OF DISCREPANCIES, PRICE THE MORE COSTLY OR EXTENSIVE WORK, UNLESS DIRECTED OTHERWISE.
 - c. WHEN TOWER IS OWNED BY A THIRD PARTY, CONTACT TOWER OWNER REPRESENTATIVE FOR PARTICIPATION IN BID WALK.
 - d. WHERE ANCHORING TO A CONCRETE ROOF SLAB, CONFIRM (PRIOR TO SUBMITTING BID) THE PRESENCE OF POST TENSION TENDONS. INCLUDE PROVISIONS FOR X-RAY PROCEDURES TO LOCATE THE TENDONS PRIOR TO CONSTRUCTION.
- 3. DRAWINGS ARE NOT TO BE SCALED. WRITTEN DIMENSIONS TAKE PRECEDENCE. CONSTRUCTION DOCUMENTS ARE INTENDED FOR DIAGRAMMATIC PURPOSES ONLY, UNO.
- 4. FURNISH ALL MATERIALS, EQUIPMENT, LABOR, AND ANY REQUIREMENTS NECESSARY TO COMPLETE PROJECT AS DESCRIBED IN THE CONSTRUCTION DOCUMENTS.
- 5. SUPERVISE AND DIRECT THE PROJECT DESCRIBED IN THE CONSTRUCTION DOCUMENTS. PROVIDE ALL CONSTRUCTION MEANS, METHODS, TECHNIQUES, SEQUENCES, AND PROCEDURES FOR COORDINATING ALL PORTIONS OF THE WORK UNDER THE CONTRACT
- 6. ALL WORK PERFORMED ON THE PROJECT AND MATERIALS INSTALLED SHALL BE IN STRICT ACCORDANCE WITH ALL APPLICABLE CODES, REGULATIONS, AND ORDINANCES. GIVE ALL NOTICES AND COMPLY WITH ALL LAWS, ORDINANCES, RULES, REGULATIONS AND LAWFUL ORDERS OF ANY PUBLIC AUTHORITY, MUNICIPAL AND UTILITY COMPANY SPECIFICATIONS, AND LOCAL AND STATE JURISDICTIONAL CODES APPLICABLE TO THE WORK.
- 7. CONSTRUCTION COORDINATION REQUIREMENTS
 - a. NOTIFY OWNER'S REPRESENTATIVE OF ANY DISCREPANCIES PRIOR TO START OF WORK.
 - b. OBTAIN ALL PERMITS. SCHEDULE AND COORDINATE ALL INSPECTIONS.
 - c. PROVIDE, AT THE PROJECT SITE, A FULL, CURRENT SET OF CONSTRUCTION DOCUMENTS FOR USE BY ALL PERSONNEL INVOLVED WITH THE PROJECT.
 - d. RECEIVE WRITTEN AUTHORIZATION TO PROCEED WITH CONSTRUCTION PRIOR TO STARTING WORK ON ANY ITEM NOT CLEARLY DEFINED BY THE CONSTRUCTION DOCUMENTS.
 - e. PERFORM WORK DURING OWNER'S PREFERRED HOURS TO AVOID DISTURBING NORMAL BUSINESS.
 - f. PROVIDE FALL PROTECTION IN ACCORDANCE WITH FEDERAL, STATE, LOCAL, AND OWNER REQUIREMENTS.
 - g. IF FAA LIGHTING AND MARKING IS PRESENT ON SITE AND IS POWERED BY ELECTRICAL SERVICE THAT IS TO BE INTERRUPTED, MAINTAIN THE NECESSARY LIGHTS DURING CONSTRUCTION AND NOTIFY THE PROPER AUTHORITIES IN THE EVENT OF A DISRUPTION.
 - h. PROVIDE A PORTABLE FIRE EXTINGUISHER WITH A RATING OF NOT LESS THAN 2-A OR 2-A10BC WITHIN 75 FEET TRAVEL DISTANCE TO ALL PORTIONS OF PROJECT AREA DURING CONSTRUCTION.
 i. STRUCTURAL COMPONENTS OF ADJACENT FACILITIES SHALL NOT BE ALTERED BY THIS
 - CONSTRUCTION PROJECT, UNO. ENSURE THAT EXCAVATION DOES NOT AFFECT ADJACENT STRUCTURES.

 i. SEAL ALL PENETRATIONS THROUGH FIRE—RATED AREAS WITH U.L. LISTED OR FIRE
 - j. SEAL ALL PENETRATIONS THROUGH FIRE—RATED AREAS WITH U.L. LISTED OR FIRE MARSHALL—APPROVED MATERIALS, IF APPLICABLE.
 - k. BURIED UTILITIES MAY EXIST IN THE AREA AND UTILITY INFORMATION SHOWN MAY NOT BE COMPLETE. CONTACT THE UTILITY LOCATE SERVICE A MINIMUM OF 48 HOURS PRIOR TO CONSTRUCTION.
 - I. COORDINATE ALL POWER INSTALLATION WITH POWER COMPANY AS REQUIRED. REPORT POWER INSTALLATION COORDINATION SOLUTION(S) TO OWNER'S REPRESENTATIVE.
 - m. PROTECT EXISTING IMPROVEMENTS, EASEMENTS, PAVING, CURBING, ETC. DURING CONSTRUCTION. UPON COMPLETION OF WORK, REPAIR ANY DAMAGE THAT MAY HAVE OCCURRED DUE TO CONSTRUCTION ON OR ABOUT THE PROPERTY.
 - n. KEEP GENERAL WORK AREA CLEAN AND HAZARD FREE DURING CONSTRUCTION AND DISPOSE OF ALL DIRT, DEBRIS, AND RUBBISH. REMOVE EQUIPMENT NOT SPECIFIED AS REMAINING ON THE PROPERTY OR PREMISES. SITE SHALL BE LEFT IN CLEAN CONDITION AND FREE FROM PAINT SPOTS, DUST, OR SMUDGES OF ANY NATURE.
 - o. MAINTAIN THE INTEGRITY OF THE BUILDING ENVELOPE AND CONSTRUCT BARRIERS IN THE AREA OF WORK TO PREVENT DAMAGE FROM WEATHER AS WELL AS FROM CONSTRUCTION DUST AND DEBRIS.
- 8. INSTALL ALL EQUIPMENT AND MATERIALS ACCORDING TO MANUFACTURER'S SPECIFICATIONS, UNO, OR WHERE LOCAL CODES OR ORDINANCES DIRECT OTHERWISE.

- 9. ANY SUBSTITUTIONS OF MATERIALS AND/OR EQUIPMENT, MUST BE APPROVED BY OWNER'S REPRESENTATIVE.
- 10. DOCUMENT ALL CHANGES MADE IN THE FIELD BY MARKING UP THE APPROVED CONSTRUCTION DRAWINGS AND SUBMITTING THE REDLINED SET TO OWNER'S REPRESENTATIVE UPON COMPLETION. DOCUMENT ALL WORK PERFORMED WITH PHOTOGRAPHS TO BE SUBMITTED WITH REDLINED CONSTRUCTION DRAWINGS.
- 11. PROVIDE SUPPORTS FOR CABLES TO THE ELEVATION OF ALL INITIAL AND FUTURE ANTENNAS IN ACCORDANCE WITH ALL MANUFACTURER'S REQUIREMENTS.
- 12. A STRUCTURAL ANALYSIS AND A MOUNT ANALYSIS (IF REQUIRED) TO DETERMINE THE STRUCTURAL CAPACITY TO SUPPORT THIS PROPOSED EQUIPMENT WAS PERFORMED OUTSIDE THE SCOPE OF THIS PROJECT.
- 13. CONFIRM THAT THE REQUIREMENTS OF THE STRUCTURAL ANALYSIS, MOUNT ANALYSIS AND ANY ASSOCIATED MODIFICATIONS HAVE BEEN FOLLOWED AND COMPLETED AS REQUIRED TO SUPPORT THE EQUIPMENT ASSOCIATED WITH THIS PROJECT.

SPECIAL INSPECTIONS:

AIR CONDITIONING

- WHEN REQUIRED, PROVIDE SPECIAL INSPECTIONS PERFORMED BY AN INDEPENDENT INSPECTOR, APPROVED BY OWNER'S REPRESENTATIVE AND THE LOCAL JURISDICTION.
- 2. THE SPECIAL INSPECTOR SHALL PROVIDE A COPY OF THE REPORT TO THE OWNER'S REPRESENTATIVE, STRUCTURAL ENGINEER, CONTRACTOR, AND BUILDING OFFICIAL.

ABBREVIATIONS

LBS

POUNDS

, ,, ,	7.111	LDO	1 001100
AFF	ABOVE FINISHED FLOOR	LTE	LONG TERM EVOLUTION
AGL	ABOVE GROUND LEVEL,	MAX	MAXIMUM
	ABOVE GRADE LEVEL	MECH	MECHANICAL
AWS	ADVANCED WIRELESS SERVICE	MTL	METAL
BBU	BATTERY BACKUP UNIT	MFR	MANUFACTURE
BLDG	BUILDING	MGR	MANAGER
BLK	BLOCKING	MIN	MINIMUM
CLG	CEILING	MISC	MISCELLANEOUS
CLR	CLEAR	NA	NOT APPLICABLE
CONC	CONCRETE	NIC	NOT IN CONTRACT
CONT	CONTINUOUS	NO	NUMBER
D	DEPTH	NTS	NOT TO SCALE
DBL	DOUBLE	OC	ON CENTER
DEG	DEGREE	OD	OUTSIDE DIAMETER
ø, DIA	DIAMETER	PCS	PERSONAL COMMUNICATION
DIAG	DIAGONAL		SERVICE
DN	DOWN	PDU	POWER DISTRIBUTION UNIT
DET	DETAIL	PROJ	PROJECT
DWG	DRAWING	PROP	PROPERTY
E	EXISTING	PT	PRESSURE TREATED
EA	EACH	PVC	POLYVINYL CHLORIDE
ELEV, EL	ELEVATION	REQ	REQUIRED
ELEC	ELECTRICAL	RF	RADIO FREQUENCY
EQ	EQUAL	RM	ROOM
EQUIP	EQUIPMENT	RO	ROUGH OPENING
EXT	EXTERIOR	RRH	REMOTE RADIO HEAD
FIF	FIBER INTERFACE FRAME,	SHT	SHEET
	FACILITY INTERFACE FRAME	SIM	SIMILAR
FIN	FINISH	SPEC	SPECIFICATION
FLUOR	FLUORESCENT	SF	SQUARE FOOT
FLR	FLOOR	SS	STAINLESS STEEL
FT	FOOT, FEET	STL	STEEL
GA	GAUGE	SUSP	SUSPENDED
GALV	GALVANIZED	TMA	TOWER MOUNTED AMPLIFIER
GC	GENERAL CONTRACTOR	TND	TINNED
GRND	GROUND	TYP	TYPICAL
GSM	GLOBAL SYSTEM MOBILE	UMTS	UNIVERSAL MOBILE
GYP	GYPSUM BOARD		TELECOMMUNICATION SERVICE
HORZ	HORIZONTAL	UNO	UNLESS NOTED OTHERWISE
HR	HOUR	VERT	VERTICAL
HT	HEIGHT	W/	WITH
ID	INSIDE DIAMETER	W/O	WITHOUT
IN	INCH, INCHES	WCS	WIRELESS COMMUNICATION
INSUL	INSULATION		SERVICE
INT	INTERIOR	WP	WATER PROOF
L	LENGTH		

PROJECT NOTES

- 1. THE FOLLOWING INFORMATION HAS BEEN PROVIDED BY SBA FOR THIS PROJECT AND HAS NOT BEEN FIELD VERIFIED AS PART OF THIS PROJECT.
 - a. SITE LAYOUT INFORMATION AND ORIENTATION
 - b. EXISTING TOWER, MOUNT AND EQUIPMENT ELEVATIONS
- c. DESIGN PACKAGE BASED ON THE APPLICATION #: 116032, v2
- 2. A STRUCTURAL ANALYSIS TO DETERMINE THE TOWER CAPACITY TO SUPPORT THIS PROPOSED EQUIPMENT WAS PERFORMED FOR SBA OUTSIDE THE SCOPE OF THIS PROJECT.
- 3. A MOUNT ANALYSIS TO DETERMINE THE MOUNT CAPACITY TO SUPPORT THIS PROPOSED EQUIPMENT WAS PERFORMED FOR SBA OUTSIDE THE SCOPE OF THIS PROJECT.
 - a. MOUNT ANALYSIS BY:b. DATED:

MASTEC NETWORK SOLUTIONS 05/24/19 SUFFICIENT

c. RESULTS: SUFFICIENT


4. CONFIRM THAT THE REQUIREMENTS OF THE STRUCTURAL ANALYSIS, MOUNT ANALYSIS AND ANY ASSOCIATED MODIFICATIONS HAVE BEEN FOLLOWED AND COMPLETED AS REQUIRED TO SUPPORT THE EQUIPMENT ASSOCIATED WITH THIS PROJECT.







6521 MERIDIEN DRIVE RALEIGH, NC 27616 PHONE: 919-755-1012 FAX: 919-755-1031

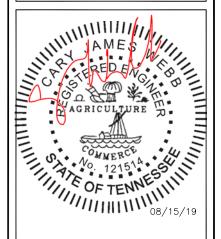

 CARY J. WEBB, P.E. TENNESSEE LICENSE NO. 121514

 DRAWN BY:
 FM

 CHECKED BY:
 DRS

 APPV'D:
 CJW

SUBMITTALS							
DATE	DESCRIPTION	REV	ISSUED BY				
08/08/19	CONSTRUCTION	0	DRS				
08/14/19	CONSTRUCTION	1	DRS				
08/15/19	CONSTRUCTION	2	DRS				

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AT&T SITE ID:

SITE ADDRESS: 1011 OLD MAIL ROAD CROSSVILLE, TN 38555-4945

FA LOCATION: 10082962

TOWER OWNER ID:

SHEET TITLE:

NOTES

SHEET NUMBER:


G-1







FDH INFRASTRUCTURE SERVICES, LLC 6521 MERIDIEN DRIVE RALEIGH, NC 27616 PHONE: 919-755-1012 FAX: 919-755-1031

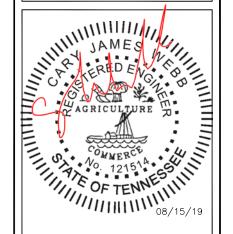

CARY J. WEBB, P.E.
TENNESSEE LICENSE NO. 121514

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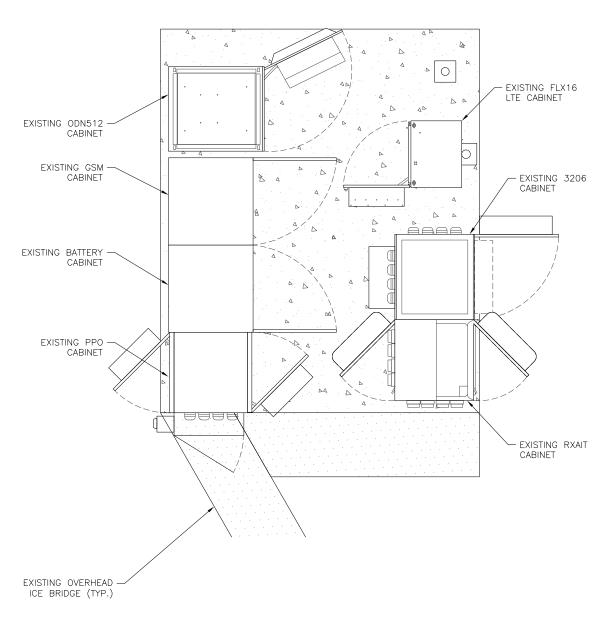
TOWER OWNER ID: TN00324-B

SHEET TITLE:

EQUIPMENT LAYOUT PLANS


SHEET NUMBER:

C-1





11"x17" SCALE: 1"=3'
24"x36" SCALE: 1"=1.5'
0 3'

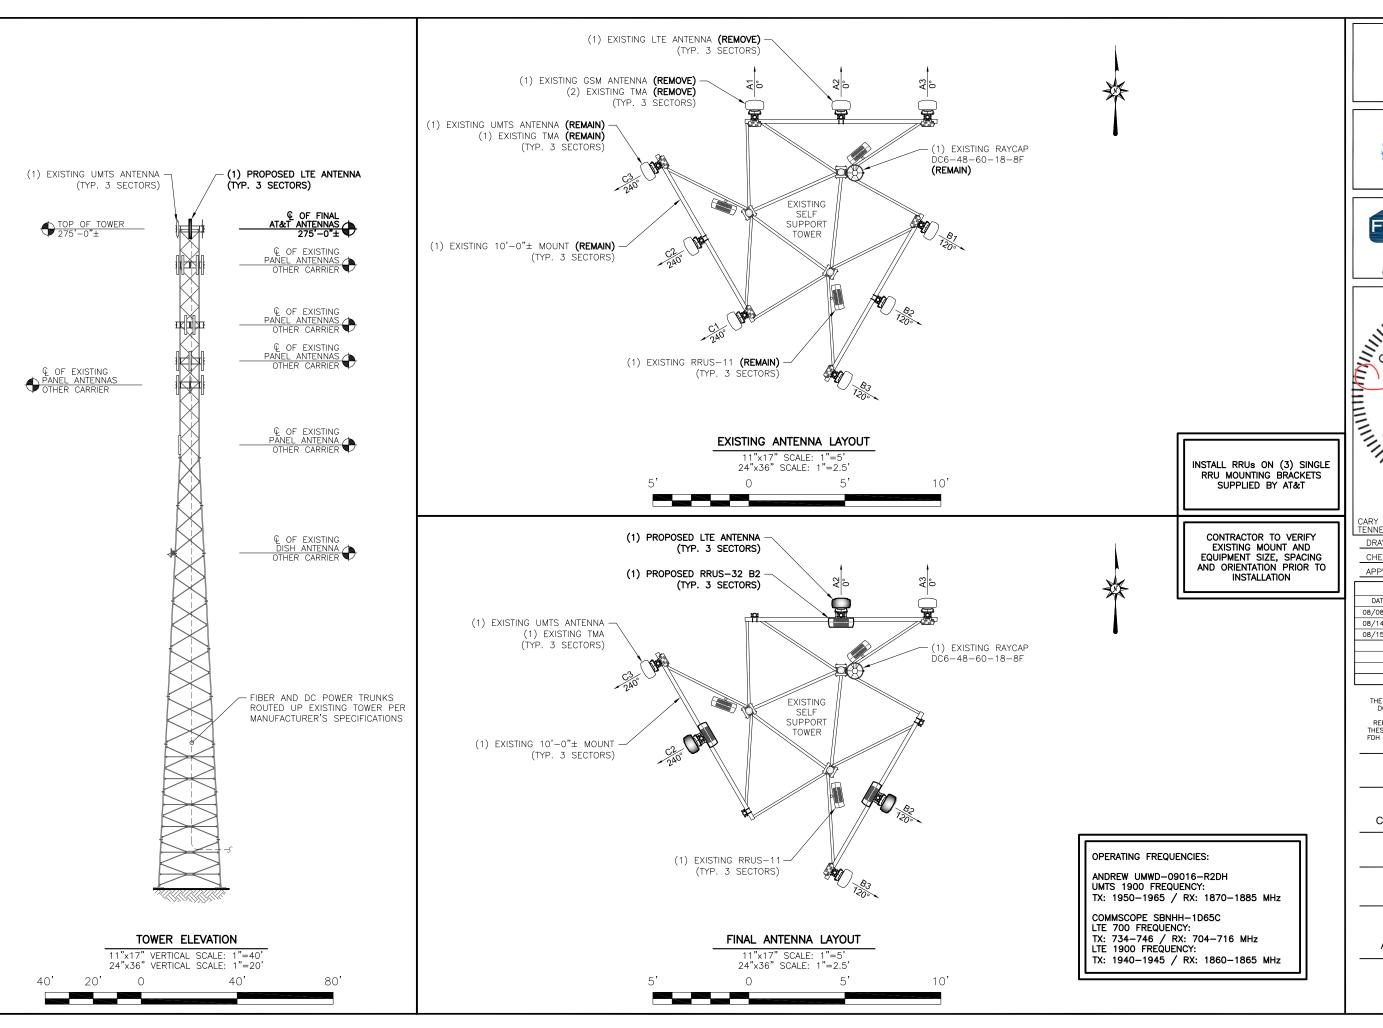








ENGINEERING INNOVATION
FOH INFRASTRUCTURE SERVICES, LLC

6521 MERIDIEN DRIVE RALEIGH, NC 27616 PHONE: 919-755-1012 FAX: 919-755-1031

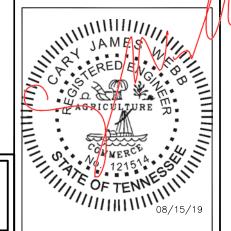

CARY J. WEBB, P.E. TENNESSEE LICENSE NO. 121514

 DRAWN BY:
 FM

 CHECKED BY:
 DRS

 APPV'D:
 CJW

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TOWER OWNER ID: TN00324-B

SHEET TITLE:

TOWER ELEVATION & ANTENNA LAYOUT PLANS

SHEET NUMBER:

C-2

SECTOR	MARK	BAND	ANTENNA MAKE/MODEL	ANTENNA & HEIGHT	ANTENNA AZIMUTH	TMA QTY./TYPE	RADIO QTY./TYPE	SURGE PROTECTION QTY./TYPE	CABLE QTY./TYPE
	A1	GSM 1900	ANDREW UMWD-09016-R2DH	275'	0,	(2) E15Z01P05	-	-	(2) 1-5/8" COAX
ALPHA	A2	LTE 700	ANDREW SBNH-1D6565C	275'	0*	-	(1) RRUS-11	(1) DC6-48-60-18-8F	(1) FIBER (2) DC POWER (1) 3/8" RET
	А3	UMTS 1900	ANDREW UMWD-09016-R2DH	275'	0,	(1) LGP18601	-	-	(1) 1-5/8" COAX
	B1	GSM 1900	ANDREW UMWD-09016-R2DH	275'	120°	(2) E15Z01P05	-	-	(2) 1-5/8" COAX
BETA	B2	LTE 700	ANDREW SBNH-1D6565C	275'	120°	-	(1) RRUS-11	-	-
	В3	UMTS 1900	ANDREW UMWD-09016-R2DH	275'	120°	(1) LGP18601	-	-	(1) 1-5/8" COAX
	C1	GSM 1900	ANDREW UMWD-09016-R2DH	275'	240°	(2) E15Z01P05	-	-	(2) 1-5/8" COAX
SAMMA	C2	LTE 700	ANDREW SBNH-1D6565C	275'	240°	-	(1) RRUS-11	-	-
	С3	UMTS 1900	ANDREW UMWD-09016-R2DH	275'	240°	(1) LGP18601	-	-	(1) 1-5/8" COAX

(6) 1-5/8" COAX TO BE REMOVED


	RESERVED ANTENNA & CABLE SCH	HEDULE		
ANTENNA TMA RRU/SPD CABLE				
-	-	(3) RRUS-11	_	







FDH INFRASTRUCTURE SERVICES, LLC
6521 MERIDIEN DRIVE RALEIGH, NC 27616
PHONE: 919-755-1012 FAX: 919-755

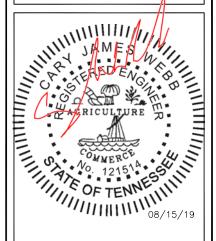

CARY J. WEBB, P.E. TENNESSEE LICENSE NO. 121514

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FA LOCATION: 10082962

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SHEET TITLE:

LEASED/EXISTING RF EQUIPMENT SCHEDULES

SHEET NUMBER:

C-3

(P) = I	PROPOSI	ED	FINAL	ANTENNA &	CABLE SC	HEDULE (ALL EQUIPMENT	MOUNTED ON TOWER)		
SECTOR	MARK	BAND	ANTENNA MAKE/MODEL	ANTENNA & HEIGHT	ANTENNA AZIMUTH	TMA QTY./TYPE	RADIO QTY./TYPE	SURGE PROTECTION QTY./TYPE	CABLE QTY./TYPE
	A1	-	-	_	-	-	-	-	-
ALPHA	A2	LTE 700/1900	COMMSCOPE SBNHH-1D65C (P)	275'	0.	-	(1) RRUS-11 (1) RRUS-32 B2 (P)	(1) DC6-48-60-18-8F	(1) FIBER (2) DC POWER (1) 3/8" RET
	А3	UMTS 1900	ANDREW UMWD-09016-R2DH	275'	0,	(1) LGP18601	-	_	(1) 1-5/8" COAX
	B1	_	-	_	-	-	-	-	-
BETA	B2	LTE 700/1900	COMMSCOPE SBNHH-1D65C (P)	275'	120*	-	(1) RRUS-11 (1) RRUS-32 B2 (P)	-	-
	В3	UMTS 1900	ANDREW UMWD-09016-R2DH	275'	120°	(1) LGP18601	-	-	(1) 1-5/8" COAX
	C1	-	-	_	-	-	-	-	-
GAMMA	C2	LTE 700/1900	COMMSCOPE SBNHH-1D65C (P)	275'	240°	-	(1) RRUS-11 (1) RRUS-32 B2 (P)	-	-
	C3	UMTS 1900	ANDREW UMWD-09016-R2DH	275'	240°	(1) LGP18601	-	-	(1) 1-5/8" COAX



ANDREW UMWD-09016-R2DH UMTS 1900 FREQUENCY: TX: 1950-1965 / RX: 1870-1885 MHz

COMMSCOPE SBNHH-1D65C LTE 700 FREQUENCY: TX: 734-746 / RX: 704-716 MHz LTE 1900 FREQUENCY: TX: 1940-1945 / RX: 1860-1865 MHz

ANTENNA NOTES:

- THIS ANTENNA ORIENTATION PLAN IS A SCHEMATIC. THE CONTRACTOR SHALL VERIFY TOWER ORIENTATION AND FIELD COORDINATE REQUIRED ADJUSTMENTS TO ACHIEVE THE DESIRED ANTENNA AZIMUTHS.
- 2. ANTENNA CENTERLINE HEIGHT REFERENCED FROM GROUND AT BASE OF TOWER, ASSUMING HEIGHT OF 0'-0" AT SAID REFERENCE POINT.
- 3. ALL ANTENNAS, CABLES AND MOUNTS SHALL BE INSTALLED IN ACCORDANCE WITH THE TOWER ENGINEER'S RECOMMENDATIONS IN A MANNER CONSISTENT WITH THE STRUCTURAL ANALYSIS REPORT.
- 4. ALL ANTENNA BRACKETS PER ANTENNA MANUFACTURER, OR EQUAL. CONTRACTOR TO COORDINATE REQUIRED MECHANICAL DOWNTILT WITH AT&T.
- 5. ALL ANTENNA INFORMATION TO BE CONFIRMED WITH AT&T RF DESIGN PRIOR TO INSTALLATION







FDH INFRASTRUCTURE SERVICES, LLC 6521 MERIDIEN DRIVE RALEIGH, NC 27616 PHONE: 919-755-1012 FAX: 919-755-1031

CARY J. WEBB, P.E. TENNESSEE LICENSE NO. 121514 DRAWN BY: DRS CHECKED BY: CJW APPV'D:

	SUBMITTALS		
DATE	DESCRIPTION	REV	ISSUED BY
08/08/19	CONSTRUCTION	0	DRS
08/14/19	CONSTRUCTION	1	DRS
08/15/19	CONSTRUCTION	2	DRS

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AT&T SITE ID: KN6173

SITE ADDRESS: 1011 OLD MAIL ROAD CROSSVILLE, TN 38555-4945

> FA LOCATION: 10082962

TOWER OWNER ID: TN00324-B

SHEET TITLE:

FINAL RF EQUIPMENT SCHEDULES

SHEET NUMBER:

C-4


RESERVED ANTENNA & CABLE SCHEDULE			
ANTENNA	TMA	RRU/SPD	CABLE
-	-	-	(1) DC POWER

GENERAL NOTES: CONTRACTOR SHALL COORDINATE INCOMING SERVICES WITH LOCAL UTILITIES PRIOR TO TRENCHING. ALL CONDUCTORS SHALL BE COPPER, 75 DEGREES C RATED, AND (2) CONDUCTOR INSULATION SHALL BE ALL TERMINATIONS SHALL BE LISTED AND IDENTIFIED FOR USE WITH 75°C RATED CONDUCTORS OPERATING AT GROUND FAULT PROTECTION REQUIRED FOR UTILITY RECEPTACLES. SERVICE NEUTRAL SHALL BE GROUNDED AT ONE LOCATION ONLY. WHITE/NEUTRAL, GREEN/GROUND SHALL BE MAINTAINED THROUGHOUT THE SITE ELECTRICAL SYSTEM (TAPE WILL NOT BE ACCEPTABLE). EQUIPMENT LOCATED OUTSIDE OR EXPOSED TO MOISTURE SHALL BE NEMA 3R RATED. CONTRACTOR SHALL USE SCHEDULE 80 PVC CONDUIT THROUGHOUT, UNLESS OTHERWISE NOTED. ALL NEWLY INSTALLED EQUIPMENT SHALL BE RATED AT 10K AIC MINIMUM. HIGHER RATINGS SHALL BE REQUIRED WHERE AVAILABLE FAULT CURRENT EXCEEDS THIS VALUE. EXACT FAULT CURRENT AVAILABLE SHALL BE COORDINATED WITH LOCAL UTILITY BASED ON EXACT CONDITIONS (TRANSFORMER SIZE, PERCENT IMPEDANCE, LENGTH OF CONDUCTORS, ETC.). D. ELECTRICAL CONTRACTOR TO VERIFY ADDITIONAL/PROPOSED LOADING DOES NOT EXCEED SYSTEM CAPACITY, PLEASE NOTIFY FDH INFRASTRUCTURE SERVICES WITH ANY DISCREPANCIES. 1 EXISTING INCOMING TELCO SERVICE FROM LOCAL DEMARCATION POINT TELCO

PLYWOOD TELCO

BACKBOARD FURNISHED

WITH POWER CABINET

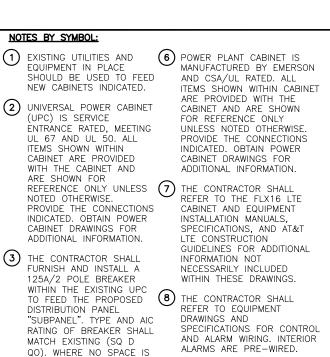

AVAILABLE, CONSOLIDATE RECEPTACLE CIRCUITS AND 9 WHERE REQUIRED, PROVIDE -48VDC POWER, ALARM, AND

LTE)

FIBER CONNECTIONS TO THE

6601 AS INDICATED.

COORDINATE WITH AT&T

10 SIAD'S SHALL BE FED FROM

4(5)

125A MLO

30A/2P

30A/2P

30A/2P

15A/1P

15A/1P

UNIVERSAL POWER (2)

CU

N.T.S.

EXISTING 125A SUBPANEL

THE CABINET THEY ARE

LOCATED WITHIN (UPC OR

CONSTRUCTION MANAGER.

AVÁILABLE, CONSOLIDATE

PROVIDE MIINI-TWIN

BREAKER TO CREATE

24VDC TO -48VDC

CONVERTERS WITH

5 CONTRACTOR SHALL PROVIDE ALL AC CIRCUIT

(4) PROVIDE AND INSTALL

SPACE. (IF REQUIRED)

DISTRIBUTION BOARD WITHIN

EXISTING AUX II CABINET.

BREAKERS REQUIRED TO

FEED AT&T EQUIPMENT. DC

CIRCUIT BREAKERS SHALL

CONTRACTOR SHALL LABEL ALL CIRCUIT BREAKERS

WITH RESPECT TO WHAT

→ POWFR

200A

125A/2F

□□□₺□SMGB

GROUND

RING

(1)

EXISTING INCOMING

POWER SERVICE

FROM LOCAL

DEMARCATION POINT

BE PROVIDED BY AT&T.


CABLE AND CONDUIT SCHEDULE							
MARK	CONE QUANT.		QUANT.	CAE SIZE	GROUND SIZE	REMARKS	
1	1	2"	3	#1	#6	AC POWER FROM UPC TO SUBPANEL (ASSUMED SIZE)	
2	1	1 1/2"	6	#8	#8	AC POWER FROM SUBPANEL TO POWER PLANT (POWER FOR RECTIFIERS) (QUANTITY OF CONDUCTORS INDICATED IS PER BREAKER)	
3	1	1"	3	#12	#12	AC POWER FROM SUBPANEL TO ANCILLIARY EQUIPMENT IN POWER PLANT	
4	1	2"		BELDIN	CABLES	ALARM CONTROL FROM POWER PLANT TO FLX16	
5	1	2"	FIBER 18-PAIR (FB-L988-A0213-XXX)			FIBER FROM UPC TO FLX16, SWEEPING BENDS	
6	1	2"	BELDIN CABLES		CABLES	ALARM CONTROL FROM UPC TO FLX16	
7	1	2"	1	#2	#2	DC POWER FROM POWER PLANT TO LTE PDB	
8	1	2"	6	#8	#8	DC POWER FROM POWER PLANT TO DC6 SURGE SUPPRESSOR	
9	1	2"	1	1 FIBER 18-PAIR FIBER FROM FLX16 TO RRUS, SWEEPING BENDS		FIBER FROM FLX16 TO RRUs, SWEEPING BENDS	
(10)	1	2"	2	3PR	DC #8 AWG	DC POWER FROM DC6 SURGE SUPPRESSOR TO RRUS	

SBA 8051 CONGRESS AVE BOCA RATON, FL 33487 (800) 487-7483





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CHECKED BY:

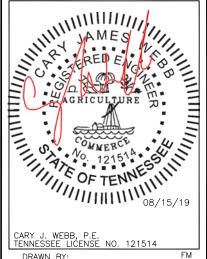DRS

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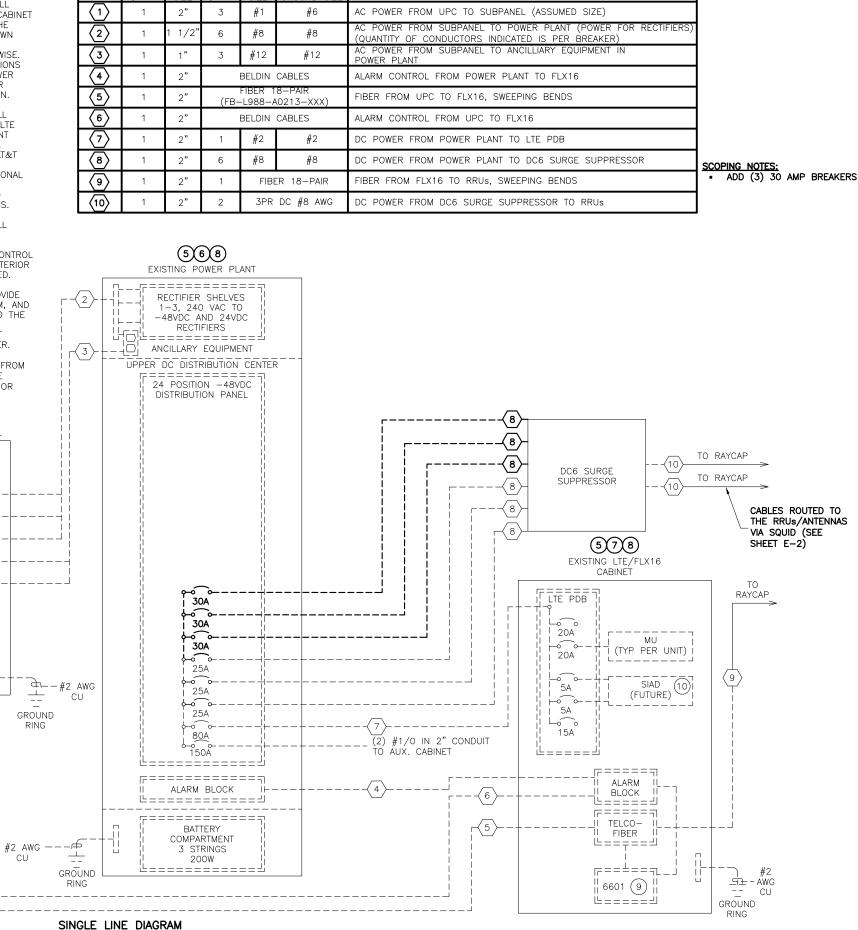
> FA LOCATION: 10082962


TOWER OWNER ID: TN00324-B

SHEET TITLE: SINGLE LINE DIAGRAM


SHEET NUMBER:

E-1



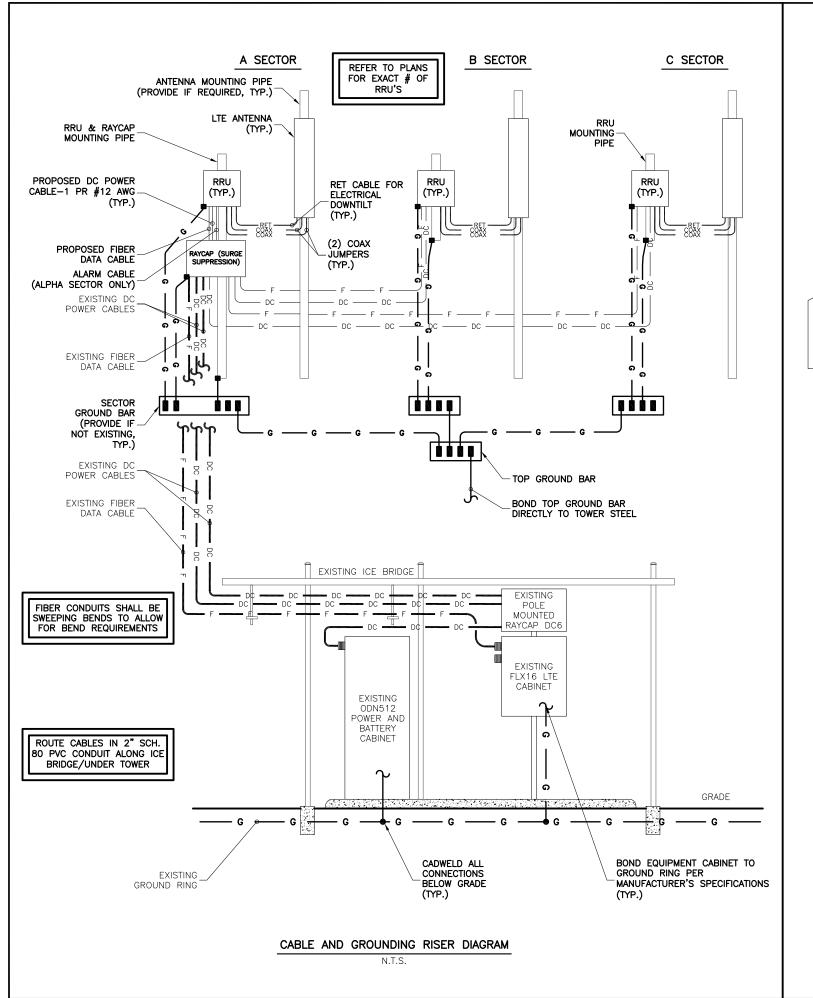

NOTE: REFER TO SHEET C-2, C-3 & C-4 FOR ADDITIONAL INFORMATION REGARDING POSSIBLE ADDITIONAL AND FUTURE ANTENNAS

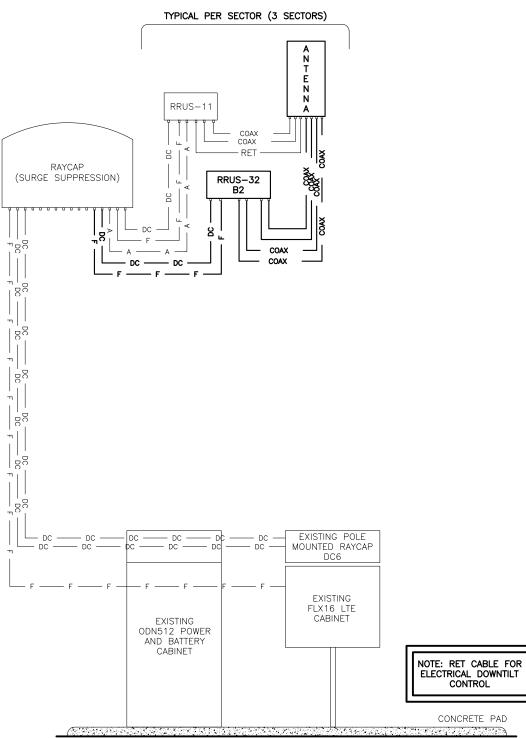

RF RISER DIAGRAM

N.T.S.








ENGINEERING INNOVATION

FDH INFRASTRUCTURE SERVICES, LLC

6521 MERIDIEN DRIVE RALEIGH, NC 27616

PHONE: 919-755-1031

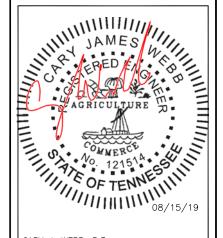

CARY J. WEBB, P.E. TENNESSEE LICENSE NO. 121514 DRAWN BY:

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 FM

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FA LOCATION: 10082962

TOWER OWNER ID: TN00324-B

SHEET TITLE:
RISER DIAGRAM

SHEET NUMBER:

E-2